
City of Harrisonburg Mountain View Drive Trail


Project Description

This project is located on a paper street right-of-way connecting Monticello Avenue and Myers Avenue, near Spotswood Elementary School. It consists of constructing approximately 340 LF of 5-ft wide gravel trail, as well as 25 LF of concrete sidewalk and two curb ramps. Re-grading and landscape reinstatement will be required. The disturbed area is estimated to be 6,830 SF.



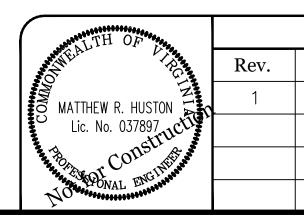

PRELIMINARY SUBJECT TO CHANGE

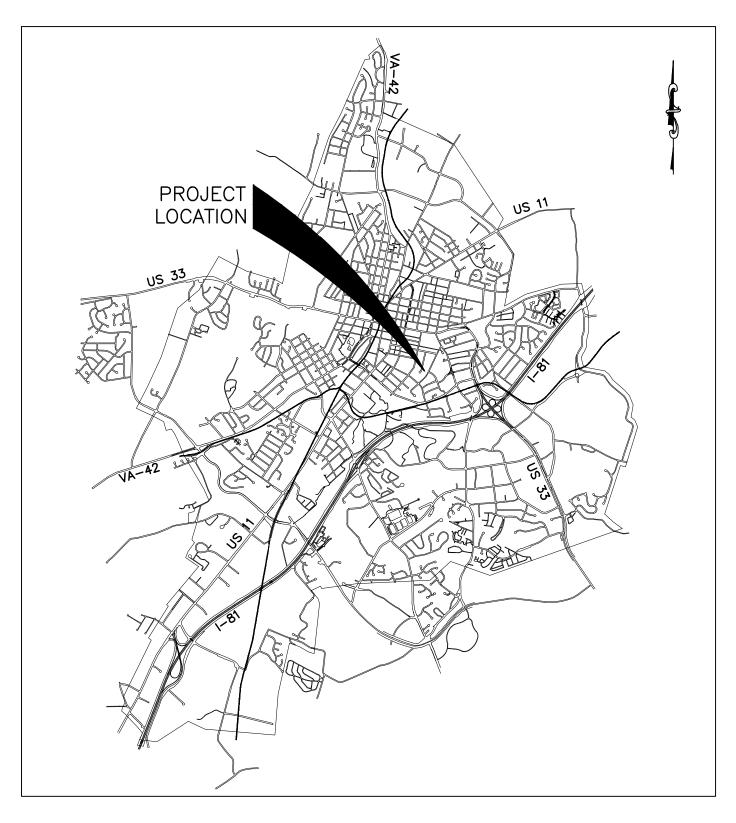

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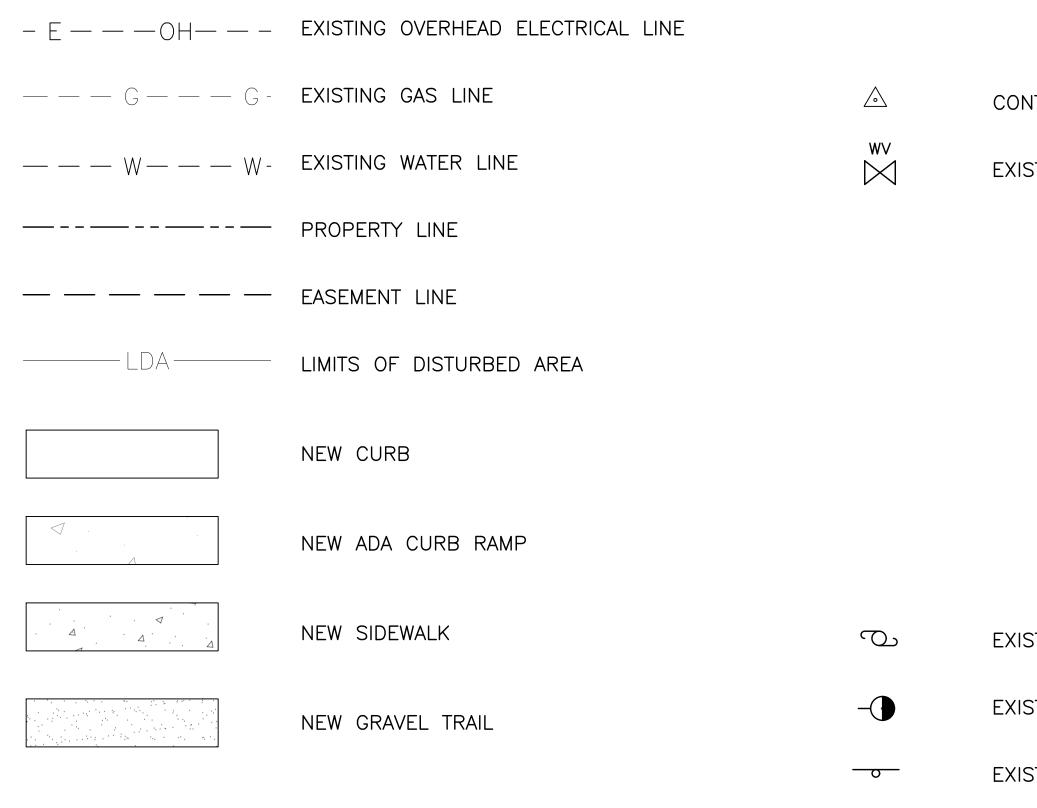
Sheet Index

1	Cover Sheet
2	Legend & Abbreviations
3	General Notes and Erosion & Sediment Control Notes
4	Geometric Control
5	Existing Conditions
6	Typical Sections
7	Civil Details
8	Plan & Profile Sta 0+00 to 2+00
9	Plan & Profile Sta 2+00 to 4+00
10	Curb Ramp Details
11	Cross Sections 1
12	Cross Sections 2
13	Cross Sections 3
14	Cross Sections 4
	Right—of—Way Exhibit

Project Contacts

	Project Manager City Engineer Public Works Public Utilities	Erin Yancey Dan Rublee Tom Hartman David Gray	(540) (540)	434-5928 432-7700 434-5928 434-9959
rg	Electric Commission Verizon Columbia Gas Comcast XFinity	Zach Nyce Chris Click Chris McDonald Philip Perry	(540) (540)	434-5361 433-7676 851-2332 266-2278

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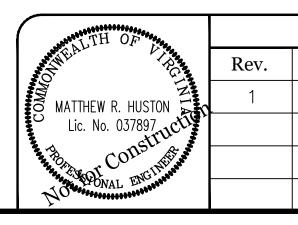
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<u>LEGEND</u>

CONTROL POINT

EXISTING WATER VALVE

EXISTING UTILITY POLE


EXISTING GUY WIRE

EXISTING SIGN

 $_{\odot}$ 42.77 TBC FINISHED SPOT EL. W/ DESCRIPTION

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City of Harrisonburg Engineering Division 409 S. Main St. Harrisonburg, VA 22801

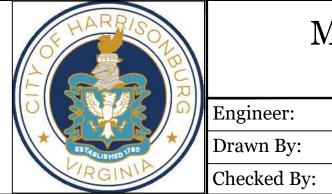

Mountain View Drive Trail Legend & Abbreviations

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CITY GENERAL NOTES

- 1. WORK FOR THIS PROJECT SHALL CONFORM TO THE LATEST EDITIONS OF THE VIRGINIA DEPARTMENT OF TRANSPORTATION (VDOT) ROAD AND BRIDGE SPECIFICATIONS, THE VDOT ROAD AND BRIDGE STANDARDS, THE VIRGINIA EROSION AND SEDIMENT CONTROL HANDBOOK, THE VIRGINIA EROSION AND SEDIMENT CONTROL REGULATIONS, AND THE CITY OF HARRISONBURG DESIGN AND CONSTRUCTION STANDARDS MANUAL. IN THE EVENT OF CONFLICT BETWEEN ANY OF THESE STANDARDS, SPECIFICATIONS OR PLANS, THE MOST STRINGENT SHALL GOVERN. ALL UTILITIES TO BE DEDICATED TO THE CITY OF HARRISONBURG MUNICIPAL WATER AND/OR SANITARY SEWER SYSTEM SHALL BE CONSTRUCTED AND TESTED TO CONFORM TO COMMONWEALTH OF VIRGINIA/STATE BOARD OF HEALTH WATERWORKS AND/OR SEWERAGE REGULATIONS AND THE CITY OF HARRISONBURG DESIGN AND CONSTRUCTION STANDARDS MANUAL.
- 2. EROSION AND SEDIMENT CONTROL MEASURES SHALL BE MAINTAINED CONTINUOUSLY, RELOCATED AS NECESSARY AND SHALL BE CHECKED AFTER EVERY RUNOFF PRODUCING RAINFALL EVENT. SEEDED AREAS SHALL BE CHECKED REGULARLY AND SHALL BE WATERED, FERTILIZED, RESEEDED, AND MULCHED AS NECESSARY TO OBTAIN A DENSE STAND OF GRASS.
- 3. ALL DRAIN INLETS SHALL BE PROTECTED FROM SILTATION. INEFFECTIVE PROTECTION DEVICES SHALL BE IMMEDIATELY REPLACED AND THE INLET CLEANED. FLUSHING IS NOT AN ACCEPTABLE METHOD OF CLEANING.
- 4. THE LOCATION OF EXISTING UTILITIES AS SHOWN IS APPROXIMATE ONLY. THE CONTRACTOR IS SOLELY RESPONSIBLE FOR LOCATING ALL PUBLIC AND PRIVATE UTILITIES WHICH LIE IN OR ADJACENT TO THE CONSTRUCTION SITE. THE CONTRACTOR SHALL BE RESPONSIBLE FOR REPAIRING, AT ITS EXPENSE, ALL EXISTING UTILITIES DAMAGED DURING CONSTRUCTION. FORTY-EIGHT (48) HOURS PRIOR TO ANY EXCAVATION CALL "MISS UTILITY" AT (800) 552-7001.
- 5. INSTALLATION OF CONCRETE STORM PIPE SHALL COMPLY WITH VDOT STANDARD DRAWING PB-1.
- 6. ALL MATERIALS USED FOR FILL OR BACKFILL SHALL BE FREE OF WOOD, ROOTS, ROCKS, BOULDERS OR ANY OTHER NON-COMPACTIBLE SOIL TYPE MATERIAL. UNSATISFACTORY MATERIALS ALSO INCLUDE MAN-MADE FILLS AND REFUSE DEBRIS DERIVED FROM ANY SOURCE.
- SATISFACTORY MATERIAL FOR USE AS FILL FOR PUBLIC STREETS INCLUDE MATERIAL CLASSIFIED IN ASTM D-2487 AS GW, GP, GM, GC, SW, SP, SM, SC, ML AND CL GROUPS. THE MOISTURE CONTENT SHALL BE CONTROLLED WITHIN PLUS OR MINUS 2 PERCENTAGE OF OPTIMUM MOISTURE CONTENT TO FACILITATE COMPACTION. GENERALLY, UNSATISFACTORY MATERIALS INCLUDE MATERIALS CLASSIFIED IN ASTM D-2487 AS PT, CH, MH, OL, OH AND ANY SOIL TOO WET TO FACILITATE COMPACTION. CH AND MH SOILS MAY BE USED SUBJECT TO APPROVAL OF THE CITY ENGINEER. SOILS SHALL HAVE A MINIMUM DRY DENSITY OF 92 LB./CU. FT. PER ASTM D-698 AND SHALL HAVE A PLASTICITY INDEX LESS THAN 12.
- MATERIALS USED TO CONSTRUCT EMBANKMENTS FOR ANY PURPOSE, BACKFILL AROUND DRAINAGE STRUCTURES OR IN UTILITY TRENCHES OR ANY OTHER DEPRESSION REQUIRING FILL OR BACKFILL SHALL BE COMPACTED TO 95% OF MAXIMUM

DENSITY. HAVE INSPECTOR INSPECT PRIOR TO ANY OPERATIONS INVOLVING FILLING OR BACKFILLING.

- OF 6-INCHES.
- PROTECT THEIR INTEGRITY.
- TO THE FACILITY.
- 12. TRAFFIC CONTROL ON PUBLIC STREETS SHALL BE IN FURTHER DIRECTED BY CITY INSPECTORS.
- 13. ANY DISCREPANCIES FOUND BETWEEN THE DRAWINGS AND SHALL PROMPTLY ADDRESS SUCH INCONSISTENCIES OR
- THE START OF THE CONSTRUCTION.

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EMBANKMENT FILL SHALL BE PLACED IN LIFTS AT A MAXIMUM UNCOMPACTED DEPTH OF 8-INCHES, AND TRENCH BACKFILL SHALL BE PLACED IN LIFTS AT A MAXIMUM UNCOMPACTED DEPTH

10. ALL EXCAVATIONS, INCLUDING TRENCHES, SHALL BE KEPT DRY TO

11. CITY INSPECTORS HAVE FULL AUTHORITY TO REJECT FILL OR BACKFILL MATERIALS, REQUIRE UNDERCUTTING OR SUBGRADE STABILIZATION, REQUIRE PROVISIONS FOR SUBDRAINAGE, OR REQUIRE OTHER MEASURES WHICH AFFECT THE INTEGRITY OF ROAD AND UTILITY CONSTRUCTION. FAILURE TO COMPLY WITH INSPECTOR'S DIRECTIVES SHALL BE CAUSE FOR NON-ACCEPTANCE

CONFORMANCE WITH THE VIRGINIA SUPPLEMENT TO THE MANUAL OF UNIFORM TRAFFIC CONTROL DEVICES (MUTCD) AND AS

SPECIFICATIONS AND SITE CONDITIONS OR ANY INCONSISTENCIES OR AMBIGUITIES IN DRAWINGS OR SPECIFICATIONS SHALL BE IMMEDIATELY REPORTED TO THE ENGINEER, IN WRITING, WHO AMBIGUITIES. WORK DONE BY THE CONTRACTOR AFTER HIS DISCOVERY OF SUCH DISCREPANCIES, INCONSISTENCIES, OR AMBIGUITIES SHALL BE DONE AT THE CONTRACTOR'S RISK.

14. A PRECONSTRUCTION CONFERENCE SHALL BE HELD PRIOR TO

EROSION & SEDIMENT CONTROL NOTES


1. UNLESS OTHERWISE INDICATED. ALL VEGETATIVE AND STRUCTURAL EROSION AND SEDIMENT CONTROL PRACTICES SHALL BE CONSTRUCTED AND MAINTAINED ACCORDING TO THE MINIMUM STANDARDS AND SPECIFICATIONS OF THE VIRGINIA EROSION AND SEDIMENT CONTROL HANDBOOK AND VIRGINIA EROSION AND SEDIMENT CONTROL REGULATIONS.

- SEDIMENT BASINS AND TRAPS, PERIMETER DIKES, SEDIMENT 2. BARRIERS AND ANY OTHER MEASURES INTENDED TO TRAP SEDIMENT SHALL BE CONSTRUCTED AS A FIRST STEP IN ANY LAND DISTURBING ACTIVITY AND SHALL BE MADE FUNCTIONAL BEFORE UPSLOPE LAND DISTURBANCES TAKE PLACE.
- 3. A COPY OF THE APPROVED EROSION AND SEDIMENT CONTROL PLAN SHALL BE MAINTAINED ON THE SITE AT ALL TIMES.
- 4. THE CONTRACTOR IS RESPONSIBLE FOR THE INSTALLATION OF ANY ADDITIONAL EROSION CONTROL MEASURES NECESSARY TO PREVENT EROSION AND SEDIMENTATION AS DETERMINED BY THE PLAN APPROVING AUTHORITY.
- 5. ALL DISTURBED AREAS ARE TO DRAIN TO APPROVED SEDIMENT CONTROL MEASURES AT ALL TIMES DURING LAND DISTURBING ACTIVITIES AND DURING SITE DEVELOPMENT UNTIL FINAL STABILIZATION IS ACHIEVED.
- 6. DURING DEWATERING OPERATIONS, WATER SHALL BE PUMPED INTO AN APPROVED FILTERING DEVICE.
- 7. THE CONTRACTOR SHALL INSPECT ALL EROSION CONTROL MEASURES PERIODICALLY AND WITHIN 24 HOURS AFTER EACH RUNOFF PRODUCING RAINFALL EVENT. ANY NECESSARY REPAIRS OR CLEANUP TO MAINTAIN THE EFFECTIVENESS OF THE EROSION CONTROL DEVICES SHALL BE MADE IMMEDIATELY.
- 8. PERMANENT OR TEMPORARY SOIL STABILIZATION SHALL BE APPLIED TO DENUDED AREAS WITHIN SEVEN (7) DAYS AFTER FINAL GRADE IS REACHED ON ANY PORTION OF THE SITE. TEMPORARY SOIL STABILIZATION SHALL BE APPLIED WITHIN SEVEN (7) DAYS TO DENUDED AREAS THAT MAY NOT BE AT FINAL GRADE BUT WILL REMAIN DORMANT (UNDISTURBED FOR LONGER THAN 30 DAYS). PERMANENT STABILIZATION SHALL BE APPLIED TO AREAS THAT ARE TO BE LEFT DORMANT FOR MORE THAN ONE YEAR.
- 9. A PERMANENT VEGETATIVE COVER SHALL BE ESTABLISHED ON DENUDED AREAS NOT OTHERWISE PERMANENTLY STABILIZED. PERMANENT VEGETATION SHALL NOT BE CONSIDERED ESTABLISHED UNTIL A GROUND COVER IS ACHIEVED THAT IS UNIFORM, MATURE ENOUGH TO SURVIVE, AND WILL INHIBIT EROSION.
- 10. DURING CONSTRUCTION OF THE PROJECT. SOIL STOCK PILES SHALL BE STABILIZED OR PROTECTED WITH SEDIMENT TRAPPING MEASURES.
- 11. CUT AND FILL SLOPES SHALL BE CONSTRUCTED IN A MANNER THAT WILL MINIMIZE EROSION. SLOPES THAT ARE FOUND TO BE ERODING EXCESSIVELY WITHIN ONE YEAR OF PERMANENT STABILIZATION SHALL BE PROVIDED WITH ADDITIONAL SLOPE STABILIZING MEASURES UNTIL THE PROBLEM IS CORRECTED.


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			Harrisonburg, VA 22801	* ESTARLISHED 1780	Drawn By:	
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- 12. ALL STORM SEWER INLETS THAT ARE MADE OPERABLE DURING CONSTRUCTION SHALL BE PROTECTED SO THAT SEDIMENT-LADEN WATER CANNOT ENTER THE CONVEYANCE SYSTEM WITHOUT FIRST BEING FILTERED OR OTHERWISE TREATED TO REMOVE SEDIMENT.
- 13. UNDERGROUND UTILITY LINES SHALL BE INSTALLED IN ACCORDANCE WITH THE FOLLOWING STANDARDS IN ADDITION TO OTHER APPLICABLE CRITERIA:
 - a) NO MORE THAN 500 LINEAR FEET OF TRENCH MAY BE OPEN AT ANY GIVEN TIME.
 - b) EXCAVATED MATERIALS SHALL BE PLACED ON THE UPHILL SIDE OF TRENCHES.
 - c) THE EFFLUENT FROM DEWATERING OPERATIONS SHALL BE FILTERED OR PASSED THROUGH AN APPROVED SEDIMENT TRAPPING DEVICE OR BOTH. THE EFFLUENT SHALL BE DISCHARGED IN A MANNER THAT DOES NOT ADVERSELY AFFECT FLOWING STREAMS OR OFFSITE PROPERTY.
 - d) MATERIAL USED FOR BACKFILLING TRENCHES SHALL BE PROPERLY COMPACTED IN ORDER TO MINIMIZE EROSION PROMOTE STABILIZATION. AND
 - e) RESTABILIZATION SHALL BE ACCOMPLISHED IN ACCORDANCE WITH THESE NOTES AND APPLICABLE **REGULATIONS.**
 - f) APPLICABLE SAFETY REGULATIONS SHALL BE COMPLIED WITH.
- 14. WHERE CONSTRUCTION VEHICLE ACCESS ROUTES INTERSECT PAVED ROAD OR PUBLIC ROADS, PROVISIONS SHALL BE MADE TO MINIMIZE THE TRANSPORT OF SEDIMENT BY VEHICULAR TRACKING ONTO THE PAVED SURFACE. WHERE SEDIMENT IS TRANSPORTED ONTO A PAVED OR PUBLIC ROAD SURFACE, THE ROAD SHALL BE CLEANED THOROUGHLY AT THE END OF EACH DAY. SEDIMENT SHALL BE REMOVED FROM THE ROAD BY SHOVELING OR SWEEPING AND TRANSPORTED TO A SEDIMENT CONTROL DISPOSAL AREA. STREET WASHING SHALL BE ALLOWED ONLY AFTER SEDIMENT IS REMOVED IN THIS MANNER.
- 15. ALL TEMPORARY EROSION AND SEDIMENT CONTROL MEASURES SHALL BE REMOVED WITHIN THIRTY (30) DAYS AFTER FINAL SITE STABILIZATION OR AFTER THE TEMPORARY MEASURES ARE NO LONGER NEEDED, UNLESS OTHERWISE AUTHORIZED BY THE LOCAL PROGRAM ADMINISTRATOR. TRAPPED SEDIMENT AND THE DISTURBED SOIL AREAS RESULTING FROM THE DISPOSITION OF TEMPORARY MEASURES SHALL BE PERMANENTLY STABILIZED TO PREVENT FURTHER EROSION AND SEDIMENTATION.

Iountain View Drive Trail General Notes NO SCALE MRH Scale: February 2021 Sheet Number: 3 MRH Date: 026, 027 Tax Map No: of 14

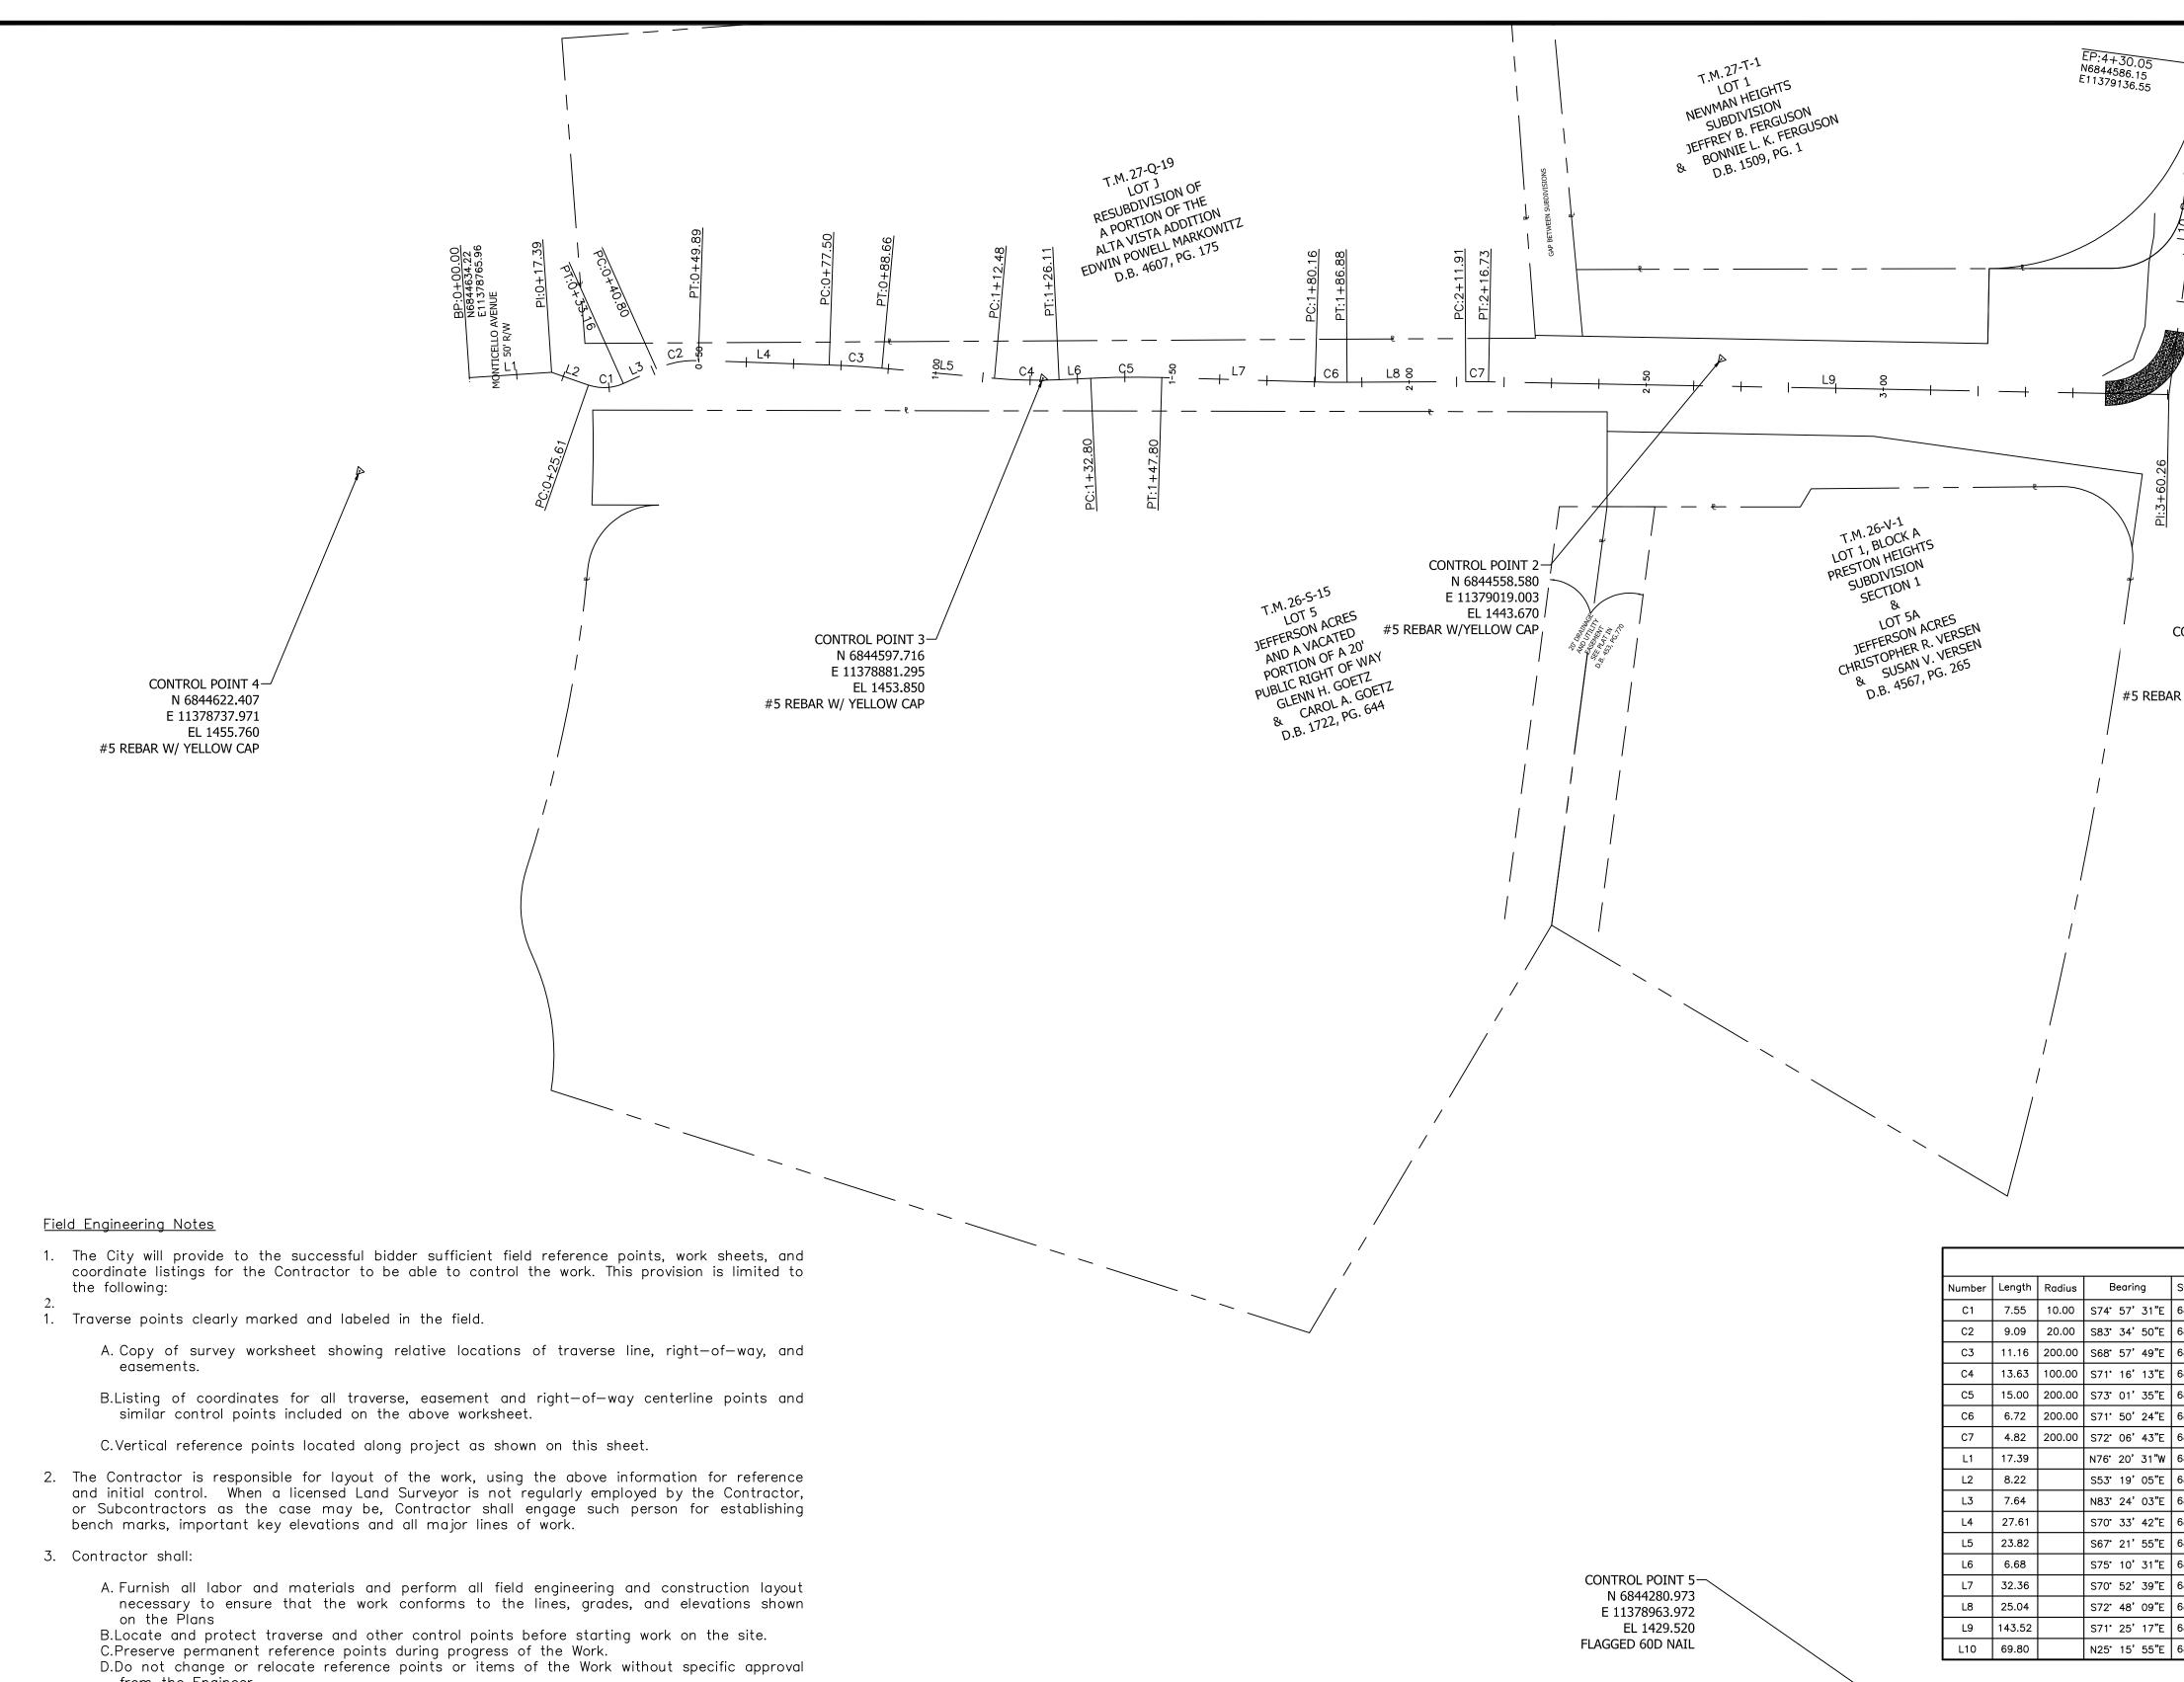


- - from the Engineer.
 - E.Promptly advise the Engineer when a reference point is lost or destroyed, or requires relocation because of other changes in the Work. F.Upon direction of the Engineer replace reference, points, stakes, or markers.
 - G.Locate such replacements according to the original survey control.

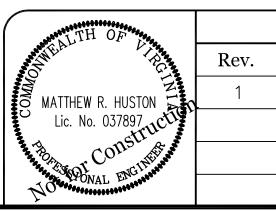



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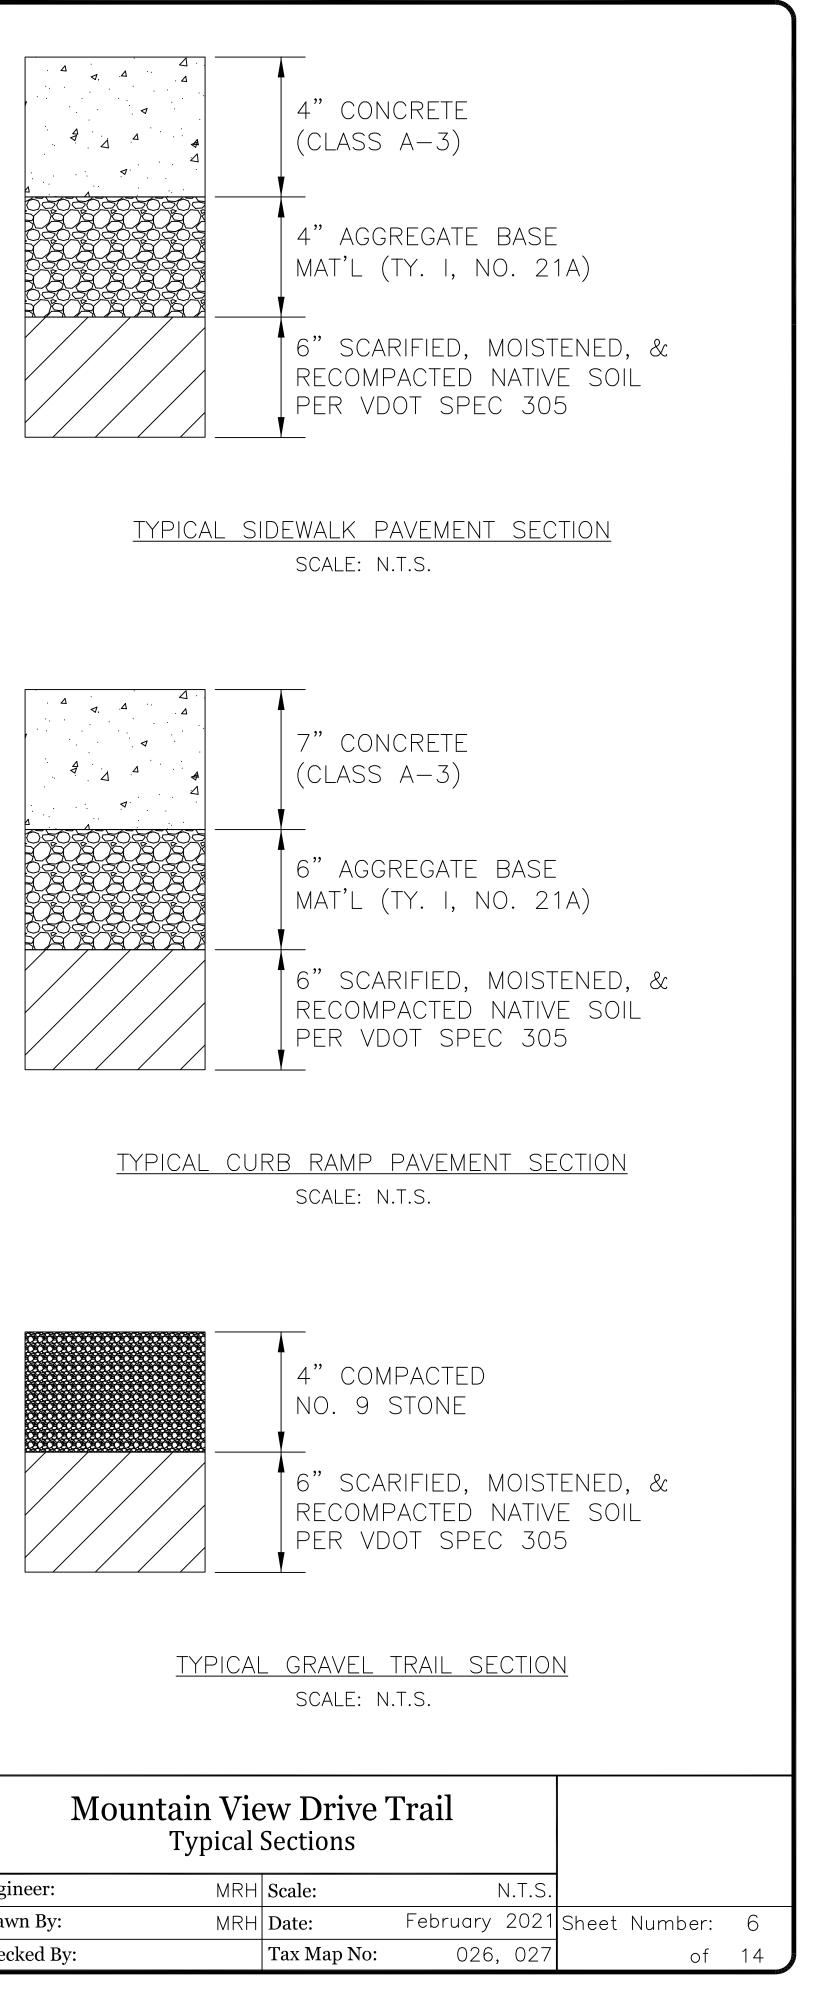
City of Harrisonburg **Engineering Division** 409 S. Main St. Harrisonburg, VA 22801

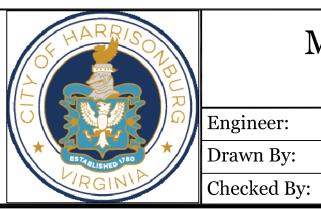

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8844579.732 11378935.831 6844577.838 11378942.215 1+80.16 1+86.88 001' 55' 30" 3.36 1+83.52 8844570.235 11378966.133 6844568.754 11378970.721 2+11.91 2+16.73 001' 52' 52" 2.41 2+14.32 8844634.215 11378765.960 6844630.109 11378782.858 001' 55' 30" 3.36 1+83.52 8844632.156 11378762.858 6844621.163 11378782.858 001' 22' 52" 2.41 2+14.32 8844632.156 11378782.858 6844624.163 11378782.458 001' 22' 52" 2.41 2+14.32 8844632.156 11378796.572 6844624.163 1137889.49 0 0 0 0 8844603.962 1137884.851 6844624.163 1137889.154 0 0 0 0 8844590.322 1137884.845 6844594.711 11378890.913 0 <td< td=""><td>6844625.199 6844624.163 6844613.967</td><td>Start Easting 11378789.449 11378804.161 11378839.154</td><td>(X) End Northing (Y) 6844623.285 6844623.156 6844609.962</td><td>11378796.572 11378813.115 11378849.567</td><td>0+25.61 0+40.80 0+77.50</td><td>0+33.16 0+49.89 0+88.66</td><td>043[•] 1 026[•] 0 003[•] 1</td><td>6'53" 2'15" 1'47"</td><td>3.97 4.62 5.58</td><td>0+29.58 0+45.43 0+83.08</td></td<>	6844625.199 6844624.163 6844613.967	Start Easting 11378789.449 11378804.161 11378839.154	(X) End Northing (Y) 6844623.285 6844623.156 6844609.962	11378796.572 11378813.115 11378849.567	0+25.61 0+40.80 0+77.50	0+33.16 0+49.89 0+88.66	043 [•] 1 026 [•] 0 003 [•] 1	6'53" 2'15" 1'47"	3.97 4.62 5.58	0+29.58 0+45.43 0+83.08	
B844634.215 11378765.960 6844630.109 11378782.858 Image: Market M	5844625.199 5844624.163 5844613.967 5844600.795	Start Easting 11378789.449 11378804.161 11378839.154 11378871.552	(X) End Northing (Y) 6844623.285 6844623.156 6844609.962 6844596.421	11378796.572 11378813.115 11378849.567 11378884.451	0+25.61 0+40.80 0+77.50 1+12.48	0+33.16 0+49.89 0+88.66 1+26.11	043 [•] 1 026 [•] 0 003 [•] 1 007 [•] 4	6' 53" 2' 15" 1' 47" 8' 36"	3.97 4.62 5.58 6.83	0+29.58 0+45.43 0+83.08 1+19.31	
6844630.109 11378782.858 6844625.199 11378789.449 <	6844625.199 6844624.163 6844613.967 6844600.795 6844594.711	 Start Easting 11378789.449 11378804.161 11378839.154 11378871.552 11378890.913 	(X) End Northing (Y) 6844623.285 6844623.156 6844609.962 6844596.421 6844590.332	11378796.572 11378813.115 11378849.567 11378884.451 11378905.258	0+25.61 0+40.80 0+77.50 1+12.48 1+32.80	0+33.16 0+49.89 0+88.66 1+26.11 1+47.80	043 [•] 1 026 [•] 0 003 [•] 1 007 [•] 4 004 [•] 1	6' 53" 2' 15" 1' 47" 8' 36" 7' 52"	3.97 4.62 5.58 6.83 7.50	0+29.58 0+45.43 0+83.08 1+19.31 1+40.30	
3844623.285 11378796.572 6844624.163 11378804.161 Image: constraint of the second seco	5844625.199 5844624.163 5844613.967 5844600.795 5844594.711 5844579.732	Start Easting 11378789.449 11378804.161 11378839.154 11378871.552 11378890.913 11378935.831	(X) End Northing (Y) 6844623.285 6844623.156 6844609.962 6844596.421 6844590.332 6844577.638	11378796.572 11378813.115 11378849.567 11378884.451 11378905.258 11378942.215	0+25.61 0+40.80 0+77.50 1+12.48 1+32.80 1+80.16	0+33.16 0+49.89 0+88.66 1+26.11 1+47.80 1+86.88	043 [•] 1 026 [•] 0 003 [•] 1 007 [•] 4 004 [•] 1 001 [•] 5	6' 53" 2' 15" 1' 47" 8' 36" 7' 52" 5' 30"	3.97 4.62 5.58 6.83 7.50 3.36	0+29.58 0+45.43 0+83.08 1+19.31 1+40.30 1+83.52	
8844623.156 11378813.115 6844613.967 11378839.154 Image: Control of the second	6844625.199 6844624.163 6844613.967 6844600.795 6844594.711 6844579.732 6844634.215	Start Easting 11378789.449 11378804.161 11378839.154 11378839.154 11378890.913 11378935.831 11378966.133 11378765.960	(X) End Northing (Y) 6844623.285 6844623.156 6844609.962 6844596.421 6844590.332 6844577.638 6844508.754 6844630.109	11378796.572 11378813.115 11378849.567 11378884.451 11378905.258 11378942.215 11378970.721 11378782.858	0+25.61 0+40.80 0+77.50 1+12.48 1+32.80 1+80.16	0+33.16 0+49.89 0+88.66 1+26.11 1+47.80 1+86.88	043 [•] 1 026 [•] 0 003 [•] 1 007 [•] 4 004 [•] 1 001 [•] 5	6' 53" 2' 15" 1' 47" 8' 36" 7' 52" 5' 30"	3.97 4.62 5.58 6.83 7.50 3.36	0+29.58 0+45.43 0+83.08 1+19.31 1+40.30 1+83.52	
8844609.962 11378849.567 6844600.795 11378871.552 Image: Control interview of the int	5844625.199 5844624.163 5844613.967 5844600.795 5844594.711 5844579.732 5844570.235 5844634.215 5844630.109	Start Easting 11378789.449 11378804.161 11378839.154 11378839.154 11378890.913 1137890.913 1137890.913 11378966.133 11378765.960 11378782.858	(X) End Northing (Y) 6844623.285 6844623.156 6844609.962 6844596.421 6844590.332 6844577.638 6844568.754 6844630.109 6844625.199	11378796.572 11378813.115 11378849.567 11378884.451 11378905.258 11378942.215 11378970.721 11378782.858 11378789.449	0+25.61 0+40.80 0+77.50 1+12.48 1+32.80 1+80.16	0+33.16 0+49.89 0+88.66 1+26.11 1+47.80 1+86.88	043 [•] 1 026 [•] 0 003 [•] 1 007 [•] 4 004 [•] 1 001 [•] 5	6' 53" 2' 15" 1' 47" 8' 36" 7' 52" 5' 30"	3.97 4.62 5.58 6.83 7.50 3.36	0+29.58 0+45.43 0+83.08 1+19.31 1+40.30 1+83.52	
5844596.421 11378884.451 6844594.711 11378890.913 Image: constraint of the second seco	5844625.199 5844624.163 5844613.967 5844600.795 5844594.711 5844579.732 5844570.235 5844634.215 5844630.109 5844623.285	Start Easting 11378789.449 11378804.161 11378804.161 11378839.154 11378839.154 11378890.913 11378935.831 11378966.133 11378765.960 11378796.572	(X) End Northing (Y) 6844623.285 6844623.156 6844609.962 6844596.421 6844590.332 6844590.332 6844577.638 6844630.109 6844625.199 6844624.163	11378796.572 11378813.115 11378849.567 11378884.451 11378905.258 11378942.215 11378970.721 11378782.858 11378789.449 11378804.161	0+25.61 0+40.80 0+77.50 1+12.48 1+32.80 1+80.16	0+33.16 0+49.89 0+88.66 1+26.11 1+47.80 1+86.88	043 [•] 1 026 [•] 0 003 [•] 1 007 [•] 4 004 [•] 1 001 [•] 5	6' 53" 2' 15" 1' 47" 8' 36" 7' 52" 5' 30"	3.97 4.62 5.58 6.83 7.50 3.36	0+29.58 0+45.43 0+83.08 1+19.31 1+40.30 1+83.52	
58844577.638 11378942.215 6844570.235 11378966.133 Image: Control intervet	6844625.199 6844624.163 6844613.967 6844600.795 6844594.711 6844579.732 6844570.235 6844634.215 6844623.285 6844623.156	 Start Easting 11378789.449 11378804.161 11378839.154 11378871.552 11378890.913 11378935.831 11378966.133 11378765.960 11378782.858 11378796.572 11378813.115 	(X) End Northing (Y) 6844623.285 6844623.156 6844609.962 6844596.421 6844590.332 6844577.638 6844568.754 6844625.199 6844625.199 6844624.163 6844613.967	11378796.572 11378813.115 11378849.567 11378884.451 11378905.258 11378942.215 11378970.721 11378782.858 11378789.449 11378804.161 11378839.154	0+25.61 0+40.80 0+77.50 1+12.48 1+32.80 1+80.16	0+33.16 0+49.89 0+88.66 1+26.11 1+47.80 1+86.88	043 [•] 1 026 [•] 0 003 [•] 1 007 [•] 4 004 [•] 1 001 [•] 5	6' 53" 2' 15" 1' 47" 8' 36" 7' 52" 5' 30"	3.97 4.62 5.58 6.83 7.50 3.36	0+29.58 0+45.43 0+83.08 1+19.31 1+40.30 1+83.52	
58844568.754 11378970.721 6844523.027 11379106.764 III IIII IIIIII IIIIIIIIIIIIIIIIIIIIIIIIIIIIIIIIIIII	6844625.199 6844624.163 6844613.967 6844600.795 6844594.711 6844579.732 6844634.215 6844630.109 6844623.285 6844623.156 6844609.962	Start Easting 11378789.449 11378804.161 11378804.161 11378839.154 11378839.154 11378839.154 11378871.552 11378890.913 11378935.831 11378966.133 11378765.960 11378765.960 11378813.115 11378849.567	(X) End Northing (Y) 6844623.285 6844623.156 6844609.962 6844596.421 6844590.332 6844590.332 684450.109 6844625.199 6844624.163 6844613.967 6844600.795	11378796.572 11378813.115 11378849.567 11378884.451 11378905.258 11378942.215 11378970.721 11378782.858 11378789.449 11378804.161 11378839.154 11378871.552	0+25.61 0+40.80 0+77.50 1+12.48 1+32.80 1+80.16	0+33.16 0+49.89 0+88.66 1+26.11 1+47.80 1+86.88	043 [•] 1 026 [•] 0 003 [•] 1 007 [•] 4 004 [•] 1 001 [•] 5	6' 53" 2' 15" 1' 47" 8' 36" 7' 52" 5' 30"	3.97 4.62 5.58 6.83 7.50 3.36	0+29.58 0+45.43 0+83.08 1+19.31 1+40.30 1+83.52	
6844523.027 11379106.764 6844586.146 11379136.554 Iountain View Drive Trail Geometric Control Image: Scale: 1" = 20' MRH Scale: 1" = 20' MRH Date: February 2021 Sheet Number: 4	6844625.199 6844624.163 6844613.967 6844600.795 6844594.711 6844579.732 6844634.215 6844630.109 6844623.156 6844609.962 6844596.421	Start Easting 11378789.449 11378804.161 11378804.161 11378839.154 11378871.552 11378890.913 11378935.831 11378966.133 11378765.960 11378782.858 11378813.115 11378849.567 11378884.451	(X) End Northing (Y) 6844623.285 6844623.156 6844609.962 6844609.322 6844596.421 6844590.332 6844577.638 684450.109 6844625.199 6844624.163 6844613.967 6844600.795 6844594.711	11378796.572 11378813.115 11378849.567 11378884.451 11378905.258 11378942.215 11378970.721 11378782.858 11378789.449 11378804.161 11378839.154 11378871.552 11378890.913	0+25.61 0+40.80 0+77.50 1+12.48 1+32.80 1+80.16	0+33.16 0+49.89 0+88.66 1+26.11 1+47.80 1+86.88	043 [•] 1 026 [•] 0 003 [•] 1 007 [•] 4 004 [•] 1 001 [•] 5	6' 53" 2' 15" 1' 47" 8' 36" 7' 52" 5' 30"	3.97 4.62 5.58 6.83 7.50 3.36	0+29.58 0+45.43 0+83.08 1+19.31 1+40.30 1+83.52	
Iountain View Drive Trail Geometric Control MRH Scale: 1" = 20' MRH Date: February 2021 Sheet Number: 4	6844625.199 6844624.163 6844613.967 6844600.795 6844594.711 6844579.732 6844634.215 6844630.109 6844623.285 6844609.962 6844590.332 6844577.638	Start Easting 11378789.449 11378804.161 11378804.161 11378804.161 11378804.161 11378804.161 11378804.161 11378804.161 11378839.154 11378871.552 11378871.552 11378935.831 11378966.133 11378765.960 11378782.858 11378782.858 11378813.115 11378849.567 11378849.567 11378884.451 11378905.258 11378942.215	(X) End Northing (Y) 6844623.285 6844623.156 6844609.962 6844609.962 6844596.421 6844590.332 6844590.332 6844500.332 684450.109 6844625.199 6844624.163 6844613.967 6844594.711 6844579.732 6844570.235	11378796.572 11378813.115 11378849.567 11378884.451 11378905.258 11378942.215 11378970.721 11378782.858 11378789.449 11378804.161 11378839.154 11378871.552 11378890.913 11378935.831 11378966.133	0+25.61 0+40.80 0+77.50 1+12.48 1+32.80 1+80.16	0+33.16 0+49.89 0+88.66 1+26.11 1+47.80 1+86.88	043 [•] 1 026 [•] 0 003 [•] 1 007 [•] 4 004 [•] 1 001 [•] 5	6' 53" 2' 15" 1' 47" 8' 36" 7' 52" 5' 30"	3.97 4.62 5.58 6.83 7.50 3.36	0+29.58 0+45.43 0+83.08 1+19.31 1+40.30 1+83.52	
Geometric ControlMRHScale:1" = 20'MRHDate:February 2021Sheet Number:4	6844625.199 6844624.163 6844613.967 6844600.795 6844594.711 6844579.732 6844630.109 6844623.285 6844623.156 6844596.421 6844590.332 6844577.638	Start Easting 11378789.449 11378789.449 11378804.161 11378839.154 11378839.154 11378890.913 11378890.913 11378935.831 11378966.133 11378765.960 11378765.960 11378813.115 11378849.567 11378884.451 11378905.258 11378970.721	(X) End Northing (Y) 6844623.285 6844623.156 6844609.962 6844609.962 6844596.421 6844590.332 6844590.332 6844590.332 684450.109 6844625.199 6844625.199 6844624.163 6844600.795 6844594.711 6844579.732 6844570.235 6844523.027	11378796.572 11378813.115 11378849.567 11378884.451 11378905.258 11378942.215 11378970.721 11378782.858 11378789.449 11378804.161 11378839.154 11378871.552 11378890.913 11378935.831 11378966.133 11379106.764	0+25.61 0+40.80 0+77.50 1+12.48 1+32.80 1+80.16	0+33.16 0+49.89 0+88.66 1+26.11 1+47.80 1+86.88	043 [•] 1 026 [•] 0 003 [•] 1 007 [•] 4 004 [•] 1 001 [•] 5	6' 53" 2' 15" 1' 47" 8' 36" 7' 52" 5' 30"	3.97 4.62 5.58 6.83 7.50 3.36	0+29.58 0+45.43 0+83.08 1+19.31 1+40.30 1+83.52	
MRH Scale: 1" = 20' MRH Date: February 2021 Sheet Number: 4	Start Northing (Y) 6844625.199 6844624.163 6844613.967 6844613.967 6844634.215 6844634.215 6844634.215 6844623.285 6844623.156 6844623.285 6844590.332 6844590.332 6844577.638 6844577.638	Start Easting 11378789.449 11378789.449 11378804.161 11378839.154 11378839.154 11378890.913 11378890.913 11378935.831 11378966.133 11378765.960 11378765.960 11378813.115 11378849.567 11378884.451 11378905.258 11378970.721	(X) End Northing (Y) 6844623.285 6844623.156 6844609.962 6844609.962 6844596.421 6844590.332 6844590.332 6844590.332 684450.109 6844625.199 6844625.199 6844624.163 6844600.795 6844594.711 6844579.732 6844570.235 6844523.027	11378796.572 11378813.115 11378849.567 11378884.451 11378905.258 11378942.215 11378970.721 11378782.858 11378789.449 11378804.161 11378839.154 11378871.552 11378890.913 11378935.831 11378966.133 11379106.764	0+25.61 0+40.80 0+77.50 1+12.48 1+32.80 1+80.16	0+33.16 0+49.89 0+88.66 1+26.11 1+47.80 1+86.88	043 [•] 1 026 [•] 0 003 [•] 1 007 [•] 4 004 [•] 1 001 [•] 5	6' 53" 2' 15" 1' 47" 8' 36" 7' 52" 5' 30"	3.97 4.62 5.58 6.83 7.50 3.36	0+29.58 0+45.43 0+83.08 1+19.31 1+40.30 1+83.52	
MRH Date: February 2021 Sheet Number: 4	6844625.199 6844624.163 6844613.967 6844600.795 6844579.732 6844579.732 6844570.235 6844634.215 6844623.285 6844623.156 6844609.962 6844596.421 6844590.332 6844577.638 6844577.638 6844523.027	 Start Easting 11378789.449 11378804.161 11378804.161 11378839.154 11378871.552 11378935.831 11378966.133 11378765.960 11378782.858 11378796.572 11378849.567 11378849.567 11378905.258 11378970.721 11378970.721 11379106.764 	(X) End Northing (Y) 6844623.285 6844623.156 6844609.962 6844609.962 6844596.421 6844590.332 6844590.332 6844500.332 6844500.332 684450.109 6844625.199 6844624.163 6844624.163 6844570.235 6844570.235 6844523.027 6844586.146	11378796.572 11378813.115 11378849.567 11378884.451 11378905.258 11378942.215 11378970.721 11378782.858 11378789.449 11378804.161 11378839.154 11378871.552 11378935.831 11378935.831 11379106.764 11379136.554	0+25.61 0+40.80 0+77.50 1+12.48 1+32.80 1+80.16	0+33.16 0+49.89 0+88.66 1+26.11 1+47.80 1+86.88	043 [•] 1 026 [•] 0 003 [•] 1 007 [•] 4 004 [•] 1 001 [•] 5	6' 53" 2' 15" 1' 47" 8' 36" 7' 52" 5' 30"	3.97 4.62 5.58 6.83 7.50 3.36	0+29.58 0+45.43 0+83.08 1+19.31 1+40.30 1+83.52	
MRH Date: February 2021 Sheet Number: 4	6844625.199 6844624.163 6844613.967 6844600.795 6844579.732 6844579.732 6844570.235 6844634.215 6844623.285 6844623.156 6844609.962 6844596.421 6844590.332 6844577.638 6844577.638 6844523.027	 Start Easting 11378789.449 11378804.161 11378804.161 11378839.154 11378871.552 11378935.831 11378966.133 11378765.960 11378782.858 11378796.572 11378849.567 11378849.567 11378905.258 11378970.721 11378970.721 11379106.764 	(X) End Northing (Y) 6844623.285 6844623.156 6844609.962 6844609.962 6844596.421 6844590.332 6844590.332 6844500.332 6844500.332 684450.109 6844625.199 6844624.163 6844624.163 6844570.235 6844570.235 6844523.027 6844586.146	11378796.572 11378813.115 11378849.567 11378884.451 11378905.258 11378942.215 11378970.721 11378782.858 11378789.449 11378804.161 11378839.154 11378871.552 11378935.831 11378935.831 11379106.764 11379136.554	0+25.61 0+40.80 0+77.50 1+12.48 1+32.80 1+80.16	0+33.16 0+49.89 0+88.66 1+26.11 1+47.80 1+86.88	043 [•] 1 026 [•] 0 003 [•] 1 007 [•] 4 004 [•] 1 001 [•] 5	6' 53" 2' 15" 1' 47" 8' 36" 7' 52" 5' 30"	3.97 4.62 5.58 6.83 7.50 3.36	0+29.58 0+45.43 0+83.08 1+19.31 1+40.30 1+83.52	
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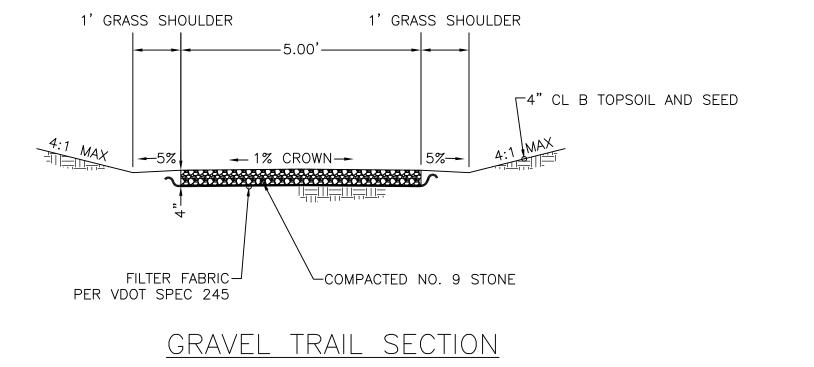


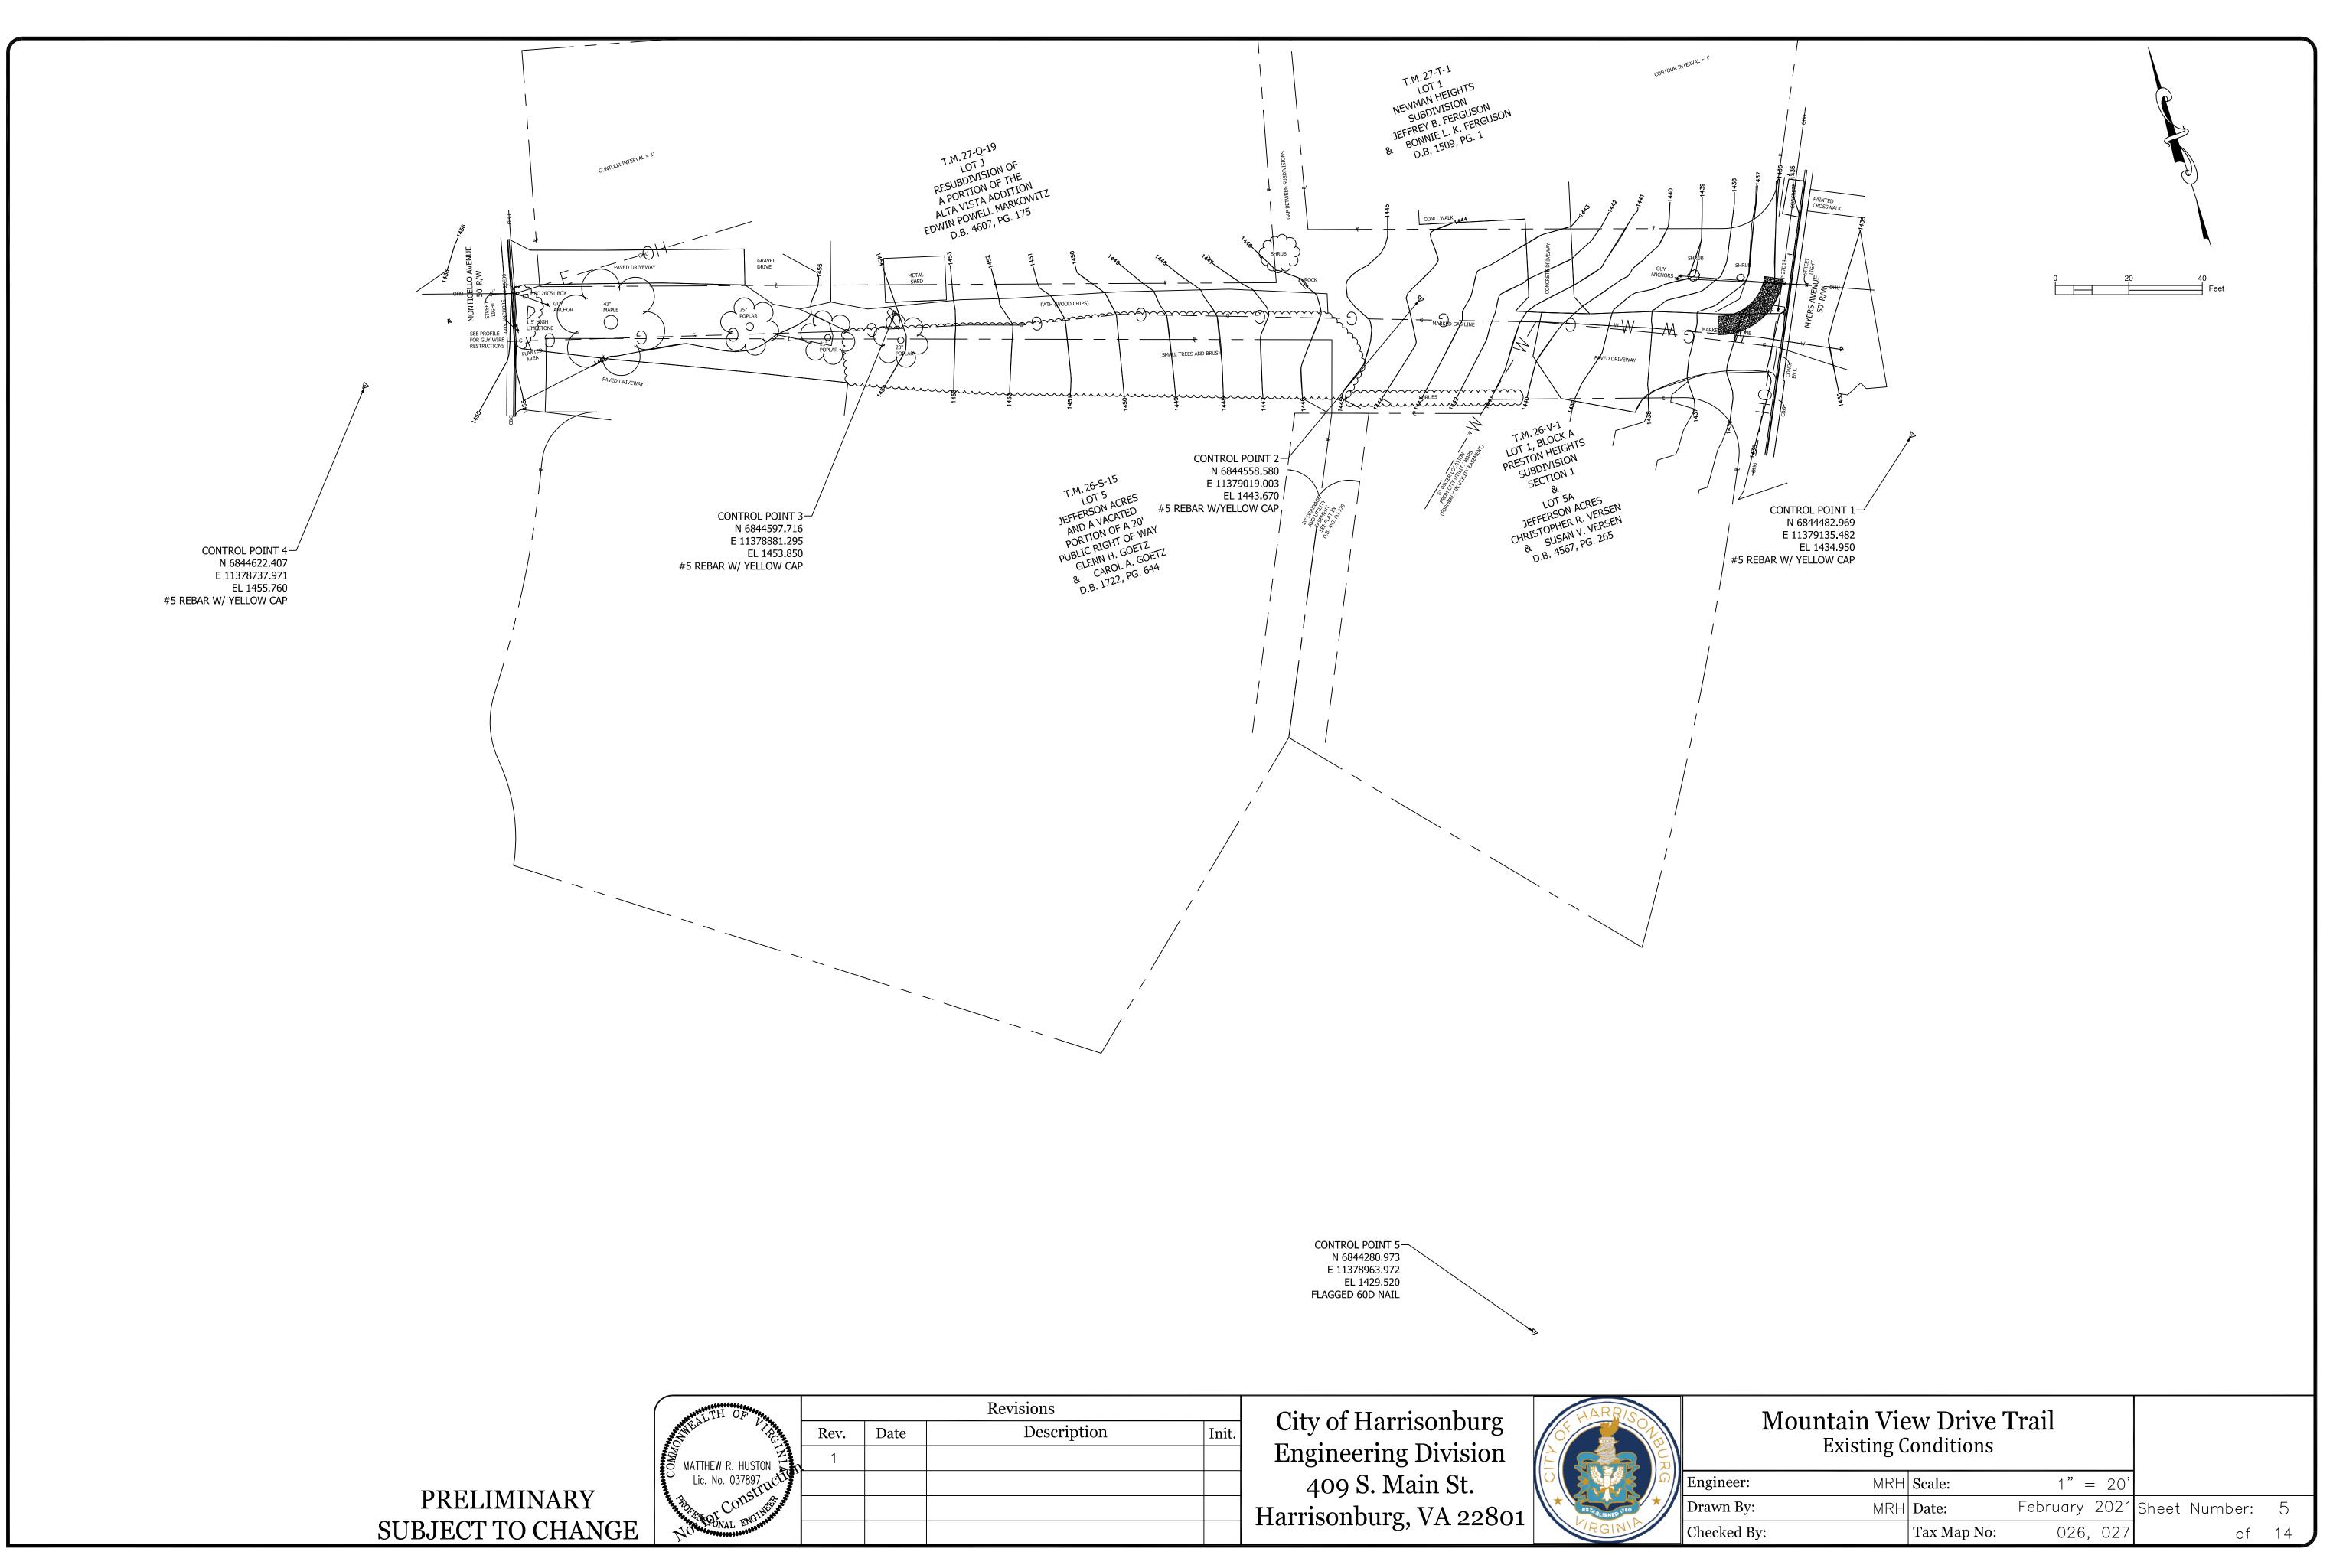


<u>NOTES</u>:

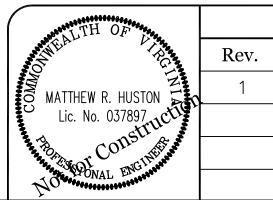
- 1. EXPANSION JOINTS SHALL BE INSTALLED EVERY 100 FT, AT ALL RADII POINTS AT CONCRETE ENTRANCES AND CURB RETURNS, AND AT LOCATIONS NO LESS THAN 6 FT AND NO MORE THAN 10 FT FROM DROP INLETS. EXPANSION MATERIAL SHALL BE $\frac{1}{2}$ " THICK AND SHALL EXTEND THE FULL DEPTH OF CONTACT SURFACE.
- 2. CONTRACTION JOINTS SHALL BE 1" DEEP BY 1/8" - 1/4" WIDE AT INTERVALS EQUAL TO SIDEWALK WIDTH.
- 3. USE $\frac{1}{4}$ " RADIUS ON ALL EDGES.
- 4. CURE FOR 72 HOURS USING CURING COMPOUND OR MOISTURE.
- 5. RECOMMENDED STONE GRADATION FOR GRAVEL TRAIL SURFACE:
- 5.1. §" SIEVE 100% PASSING
- 5.2. $\frac{1}{4}$ " SIEVE 65% PASSING
- 5.3. <u>3</u>" SIEVE 50% PASSING 5.4. $\frac{1}{8}$ " SIEVE - 35% PASSING
- 5.5. $\frac{1}{16}$ " SIEVE 25% PASSING







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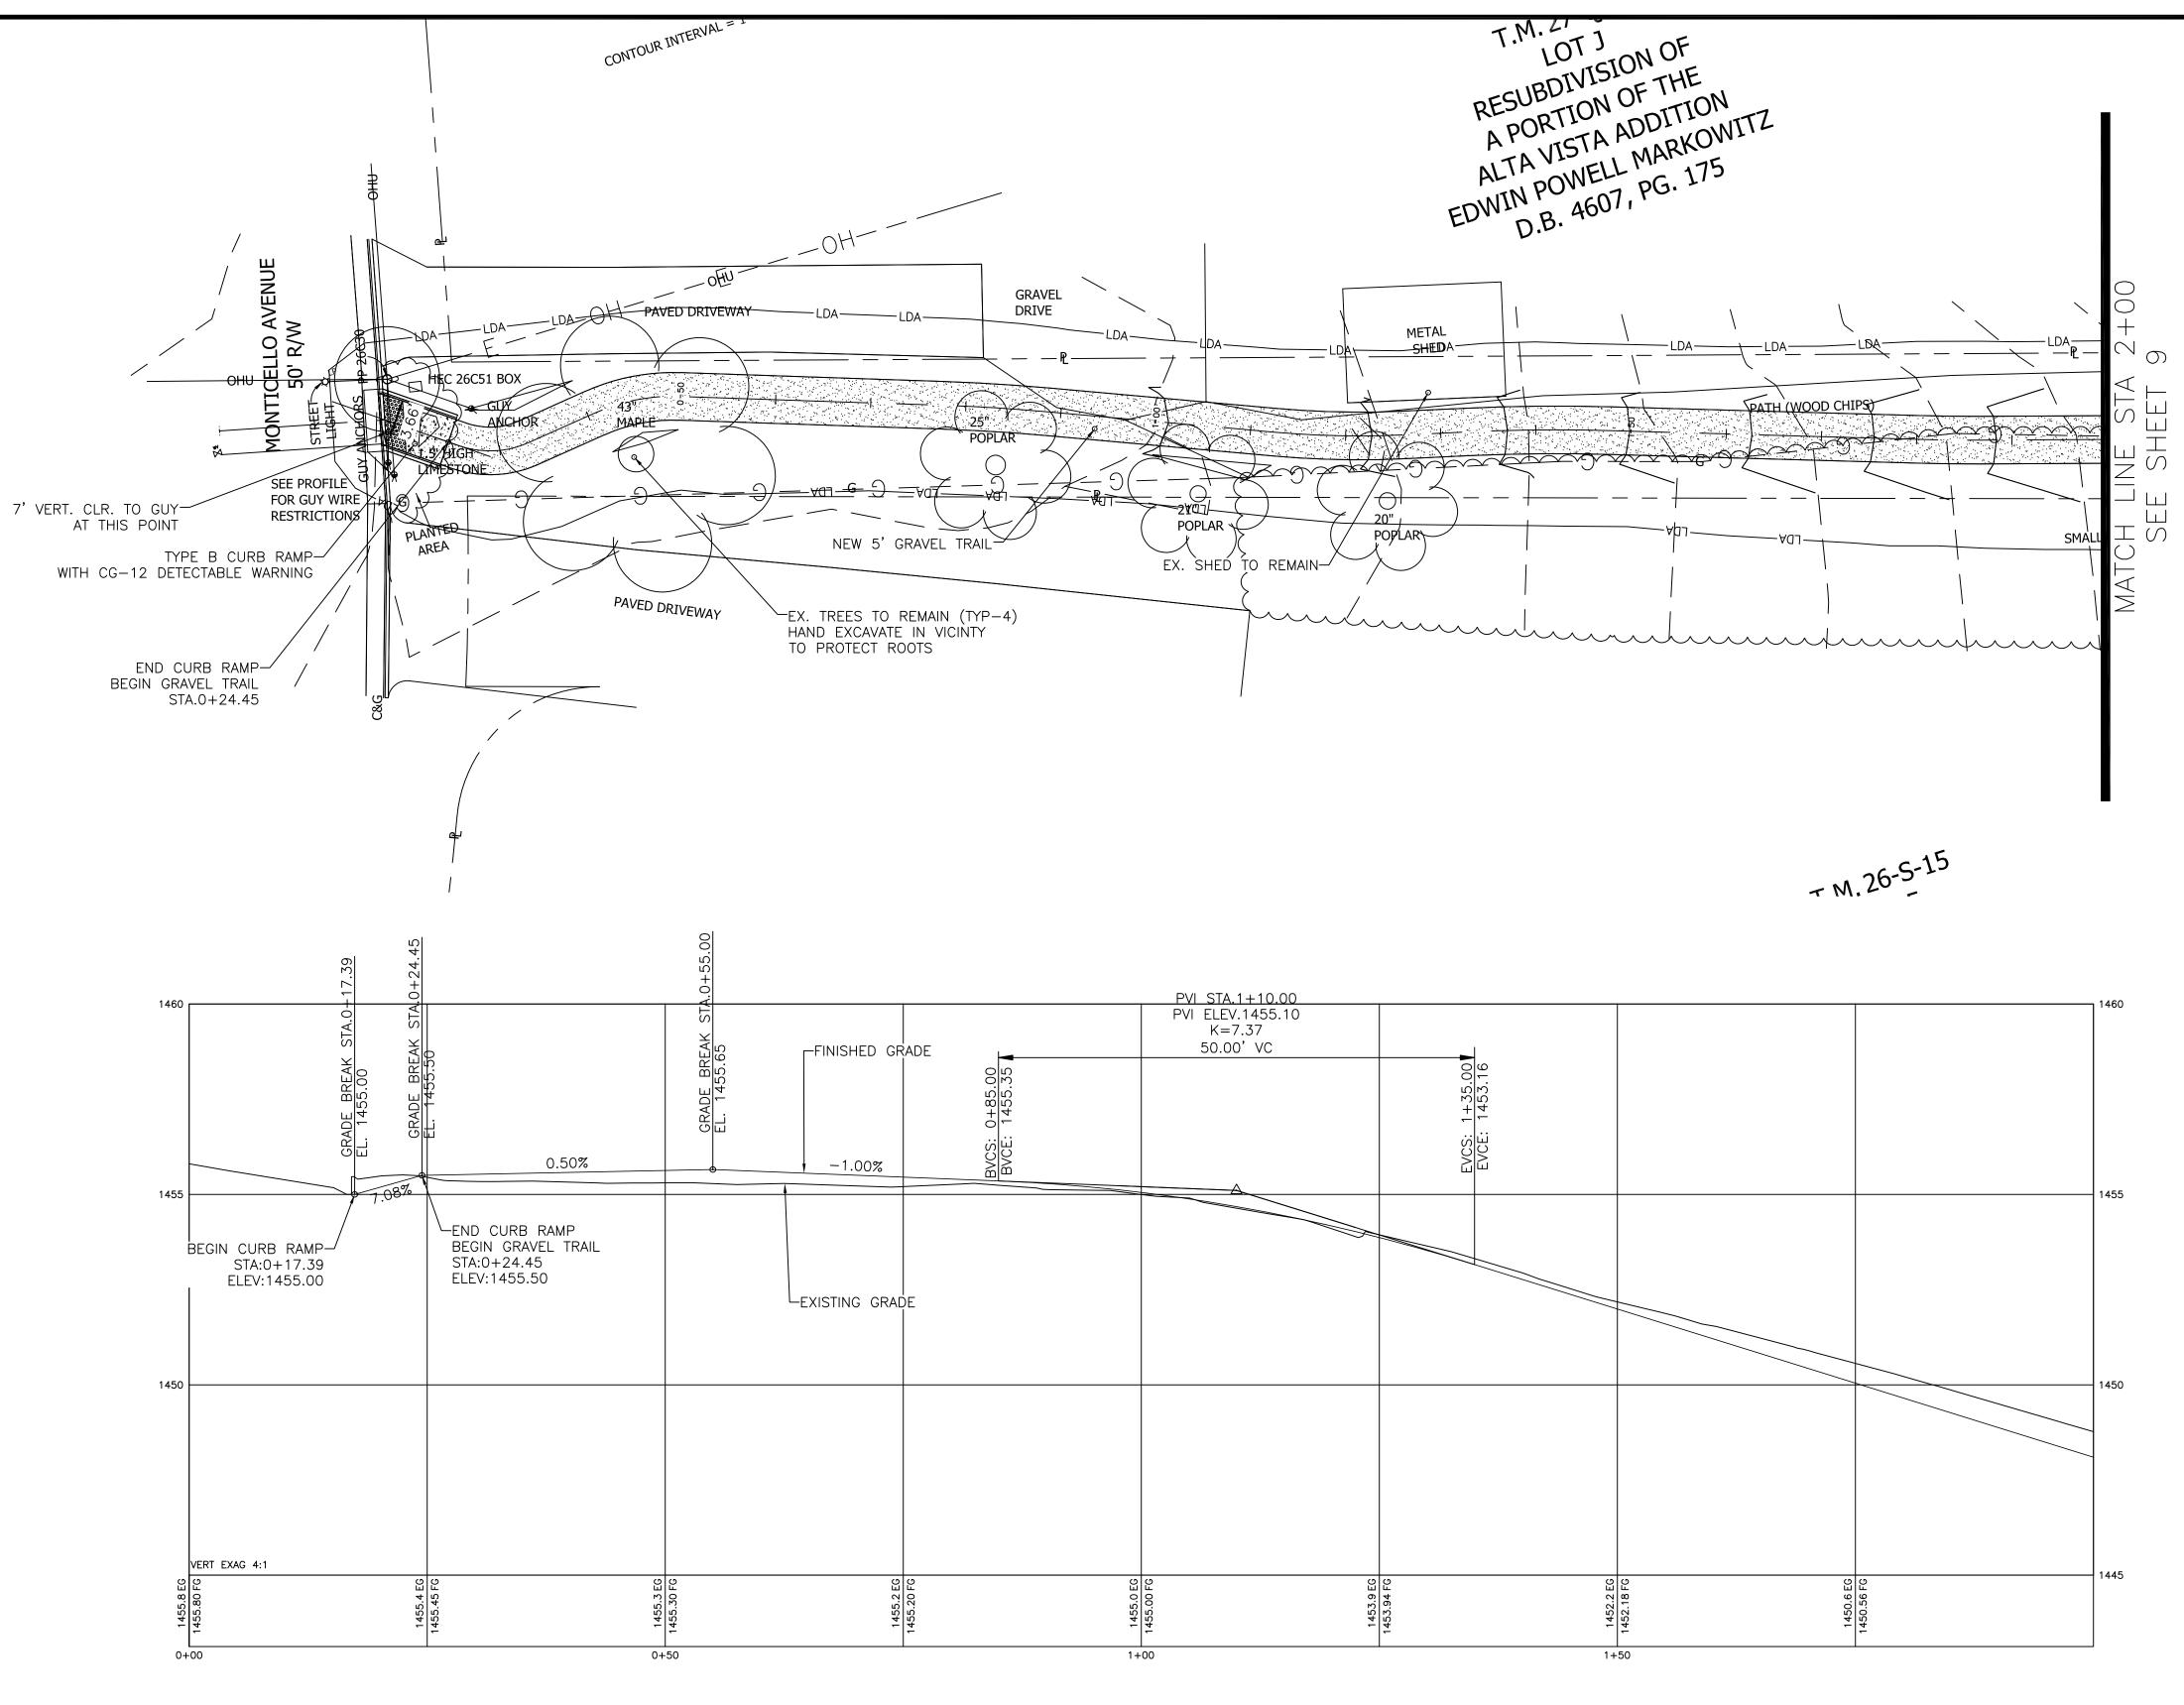


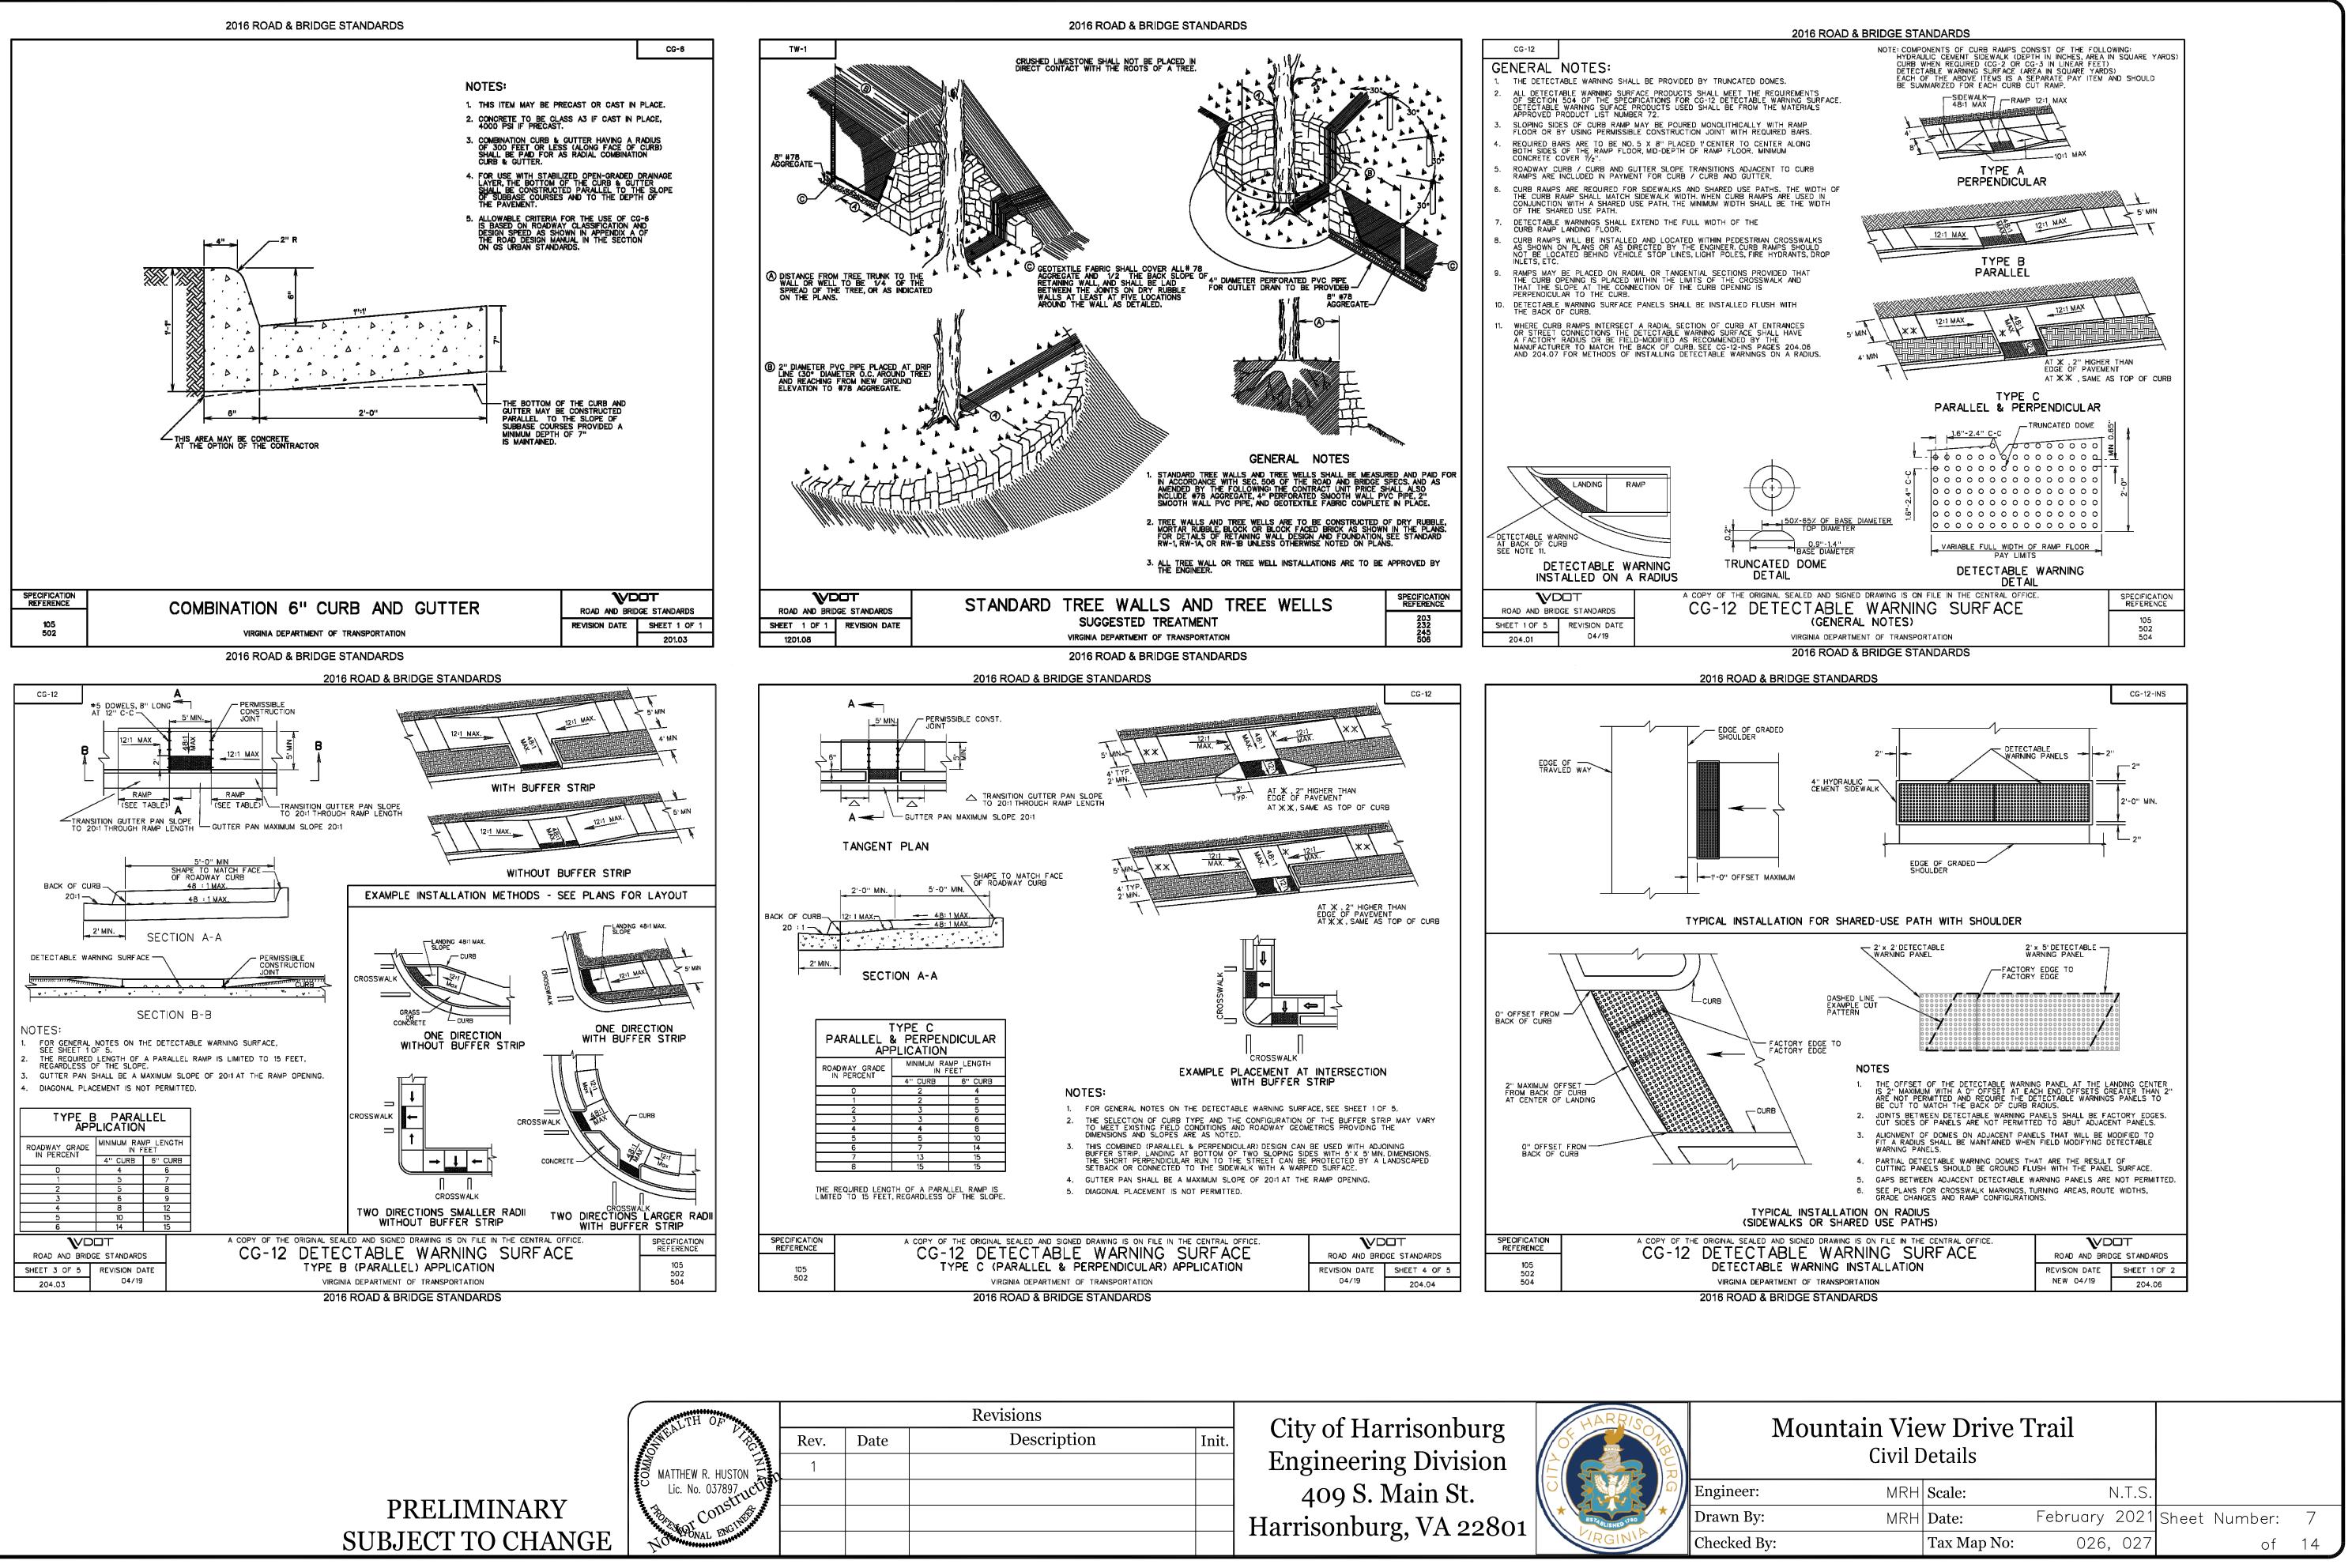
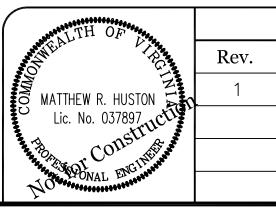
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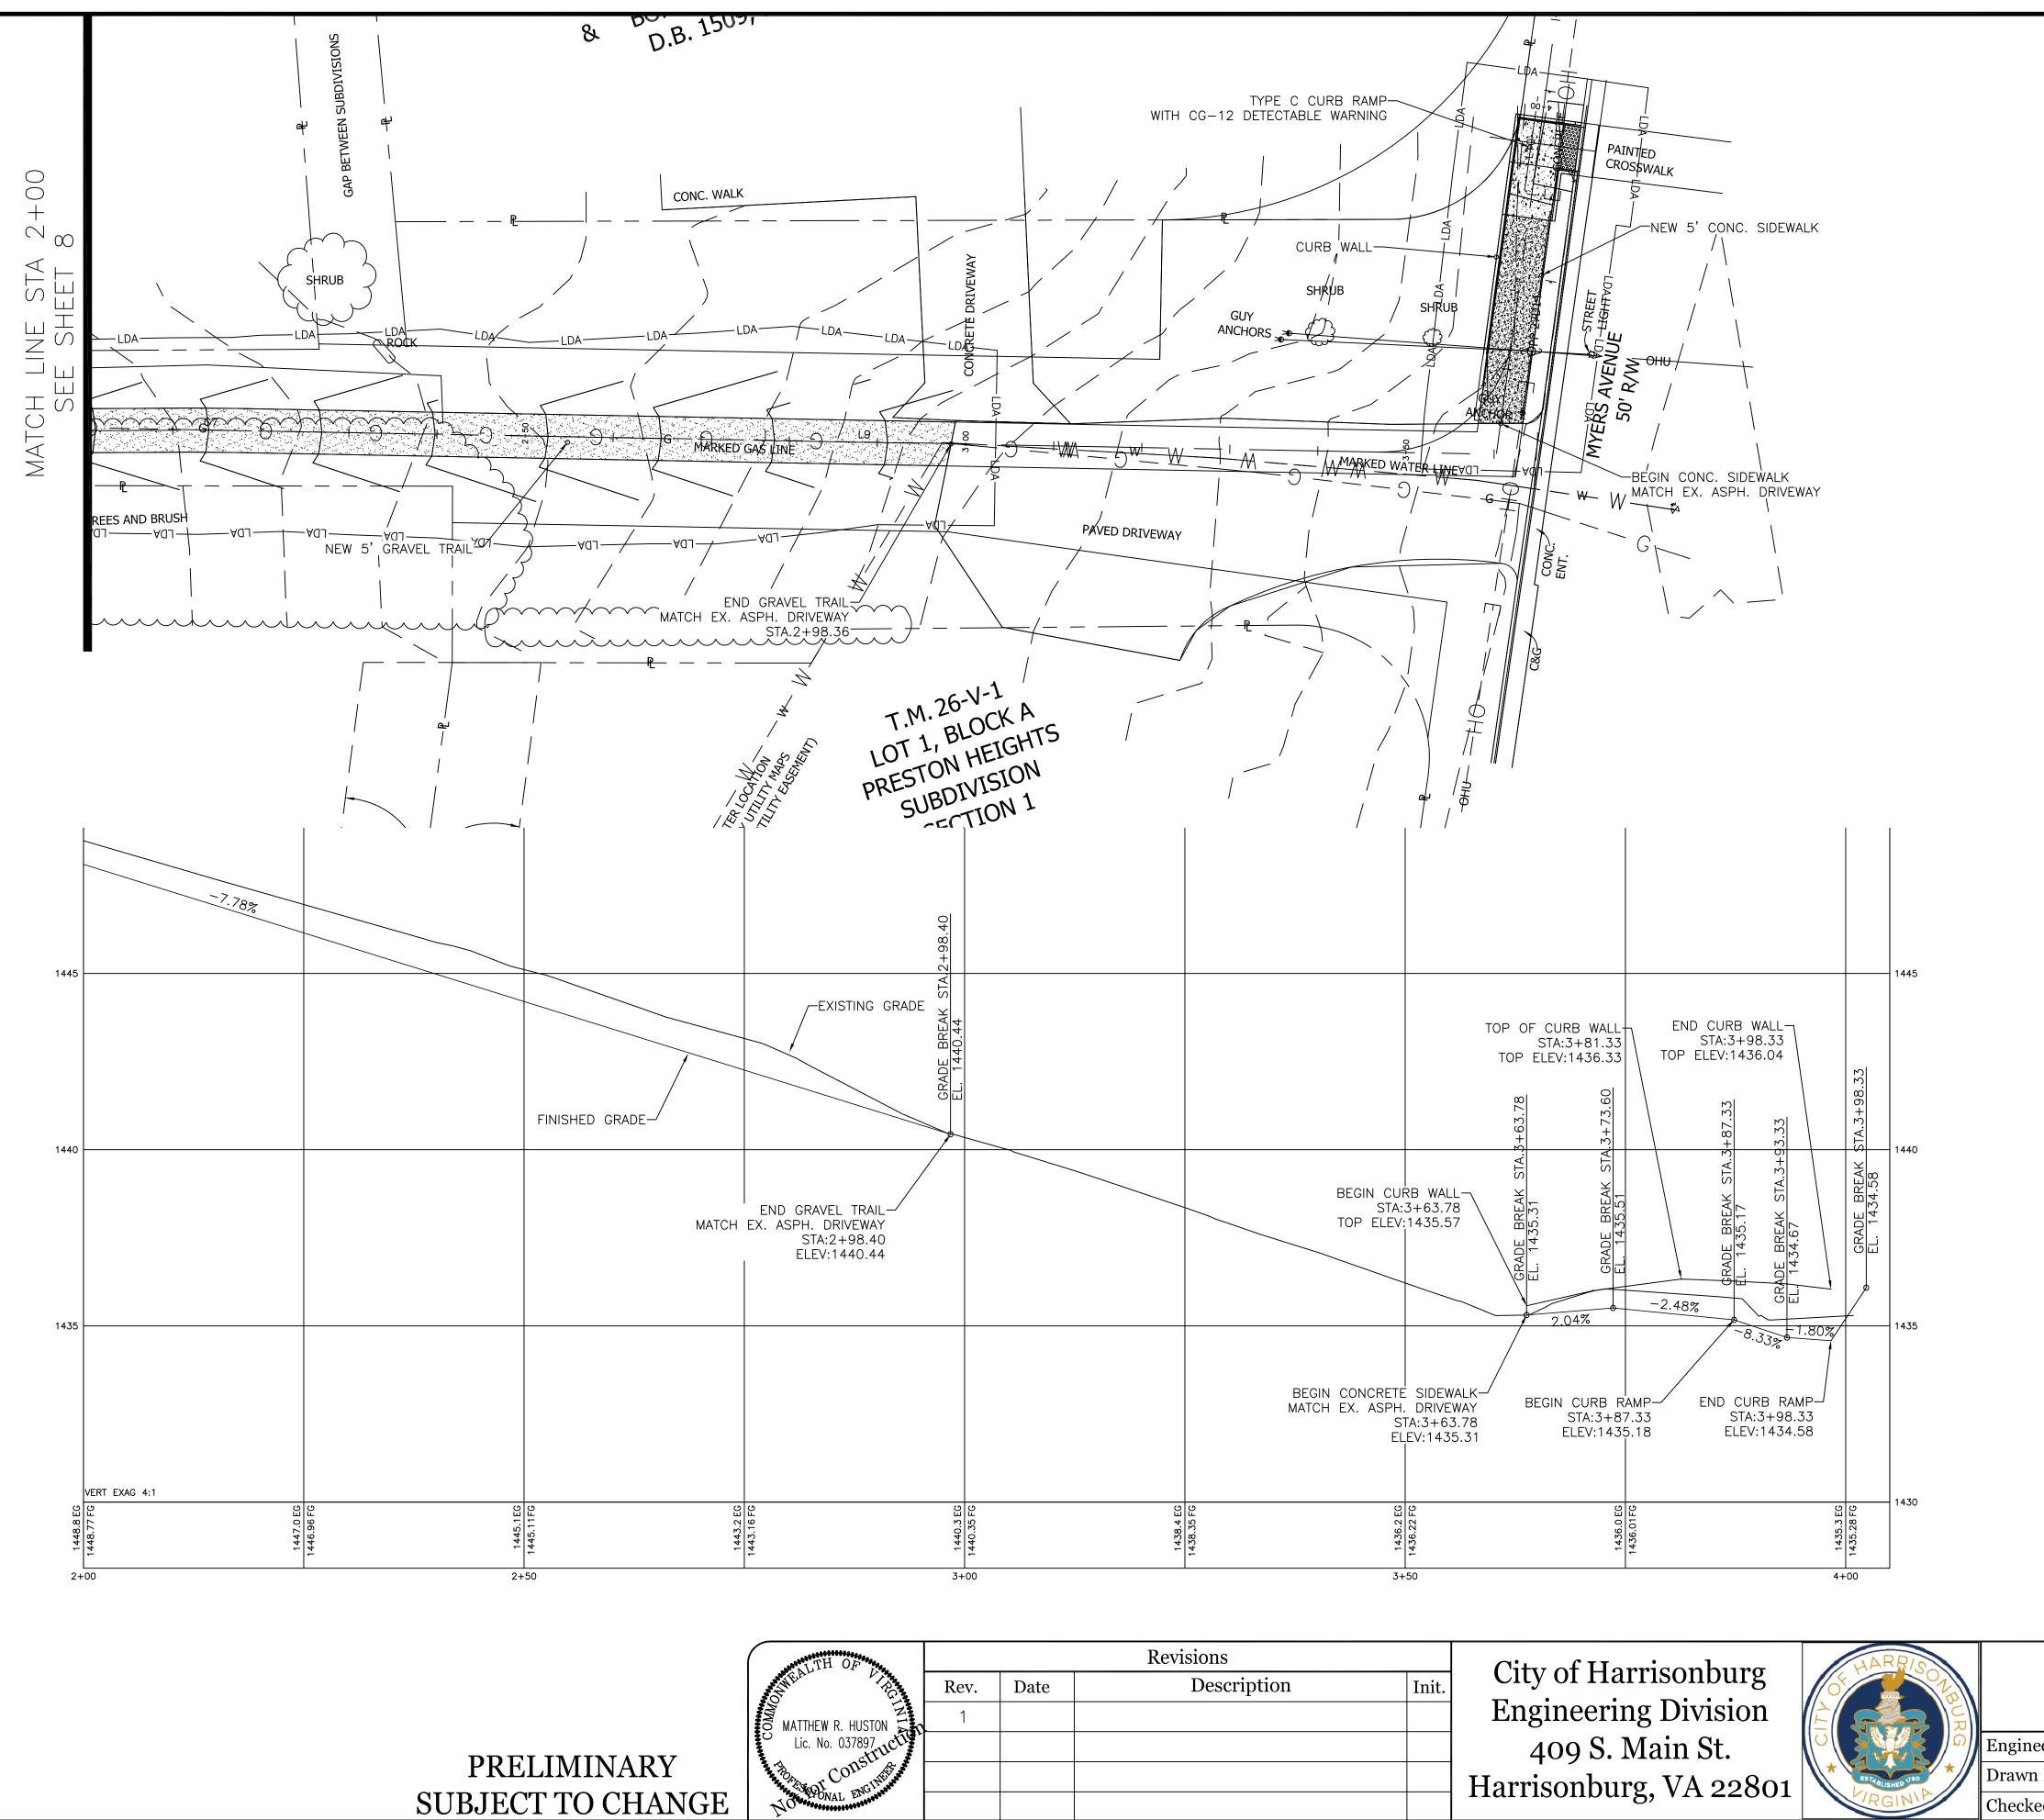




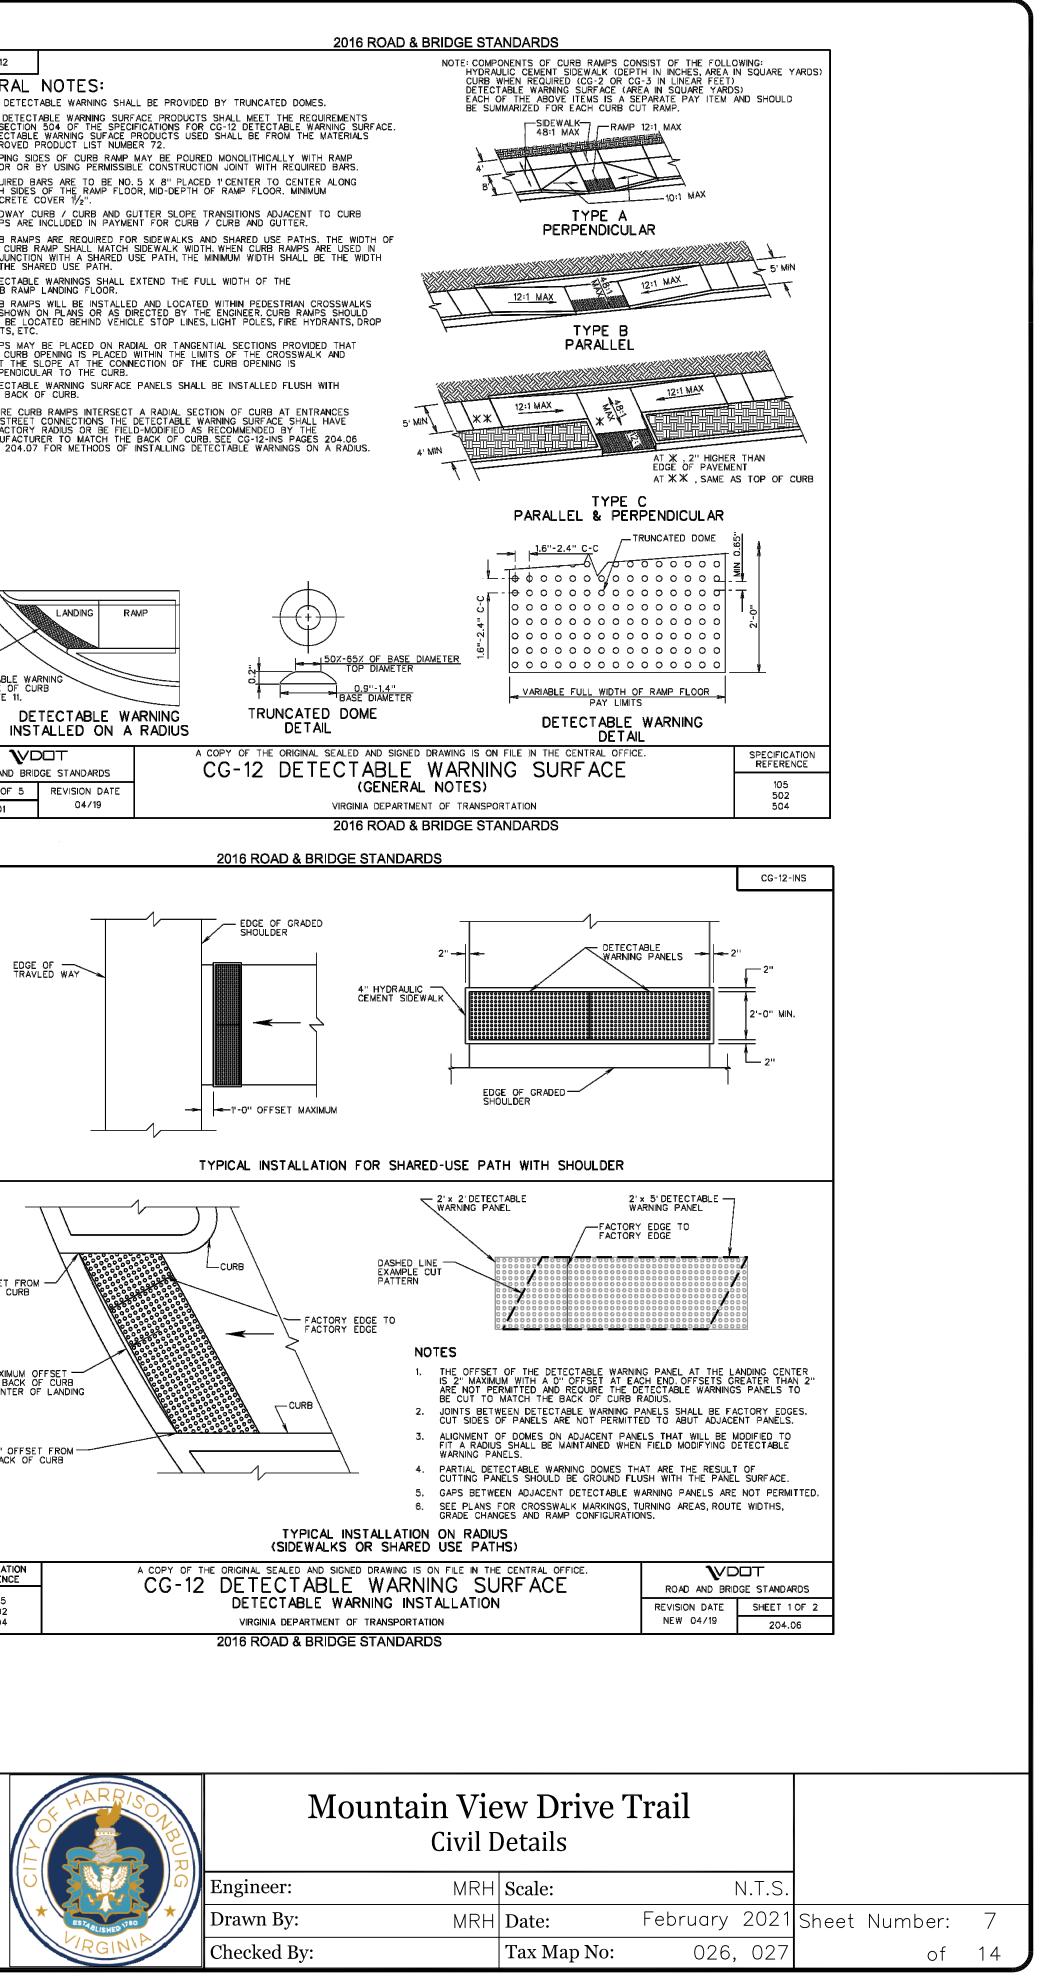

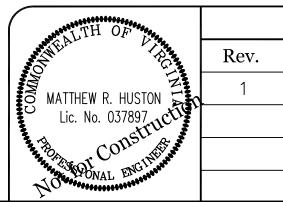
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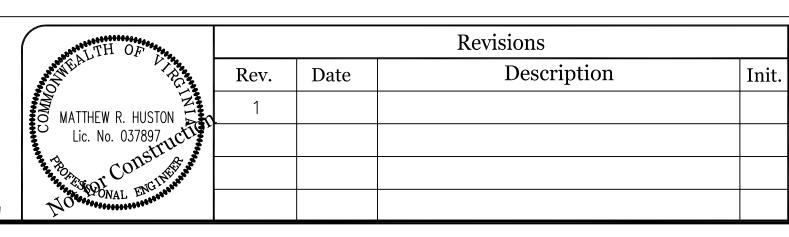



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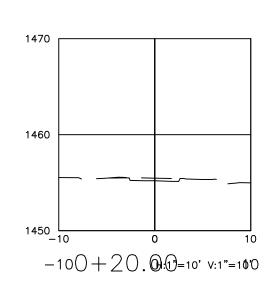
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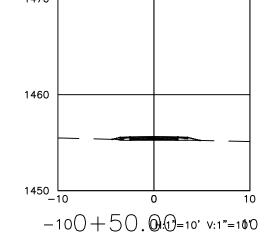



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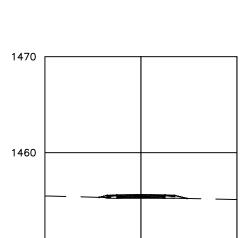







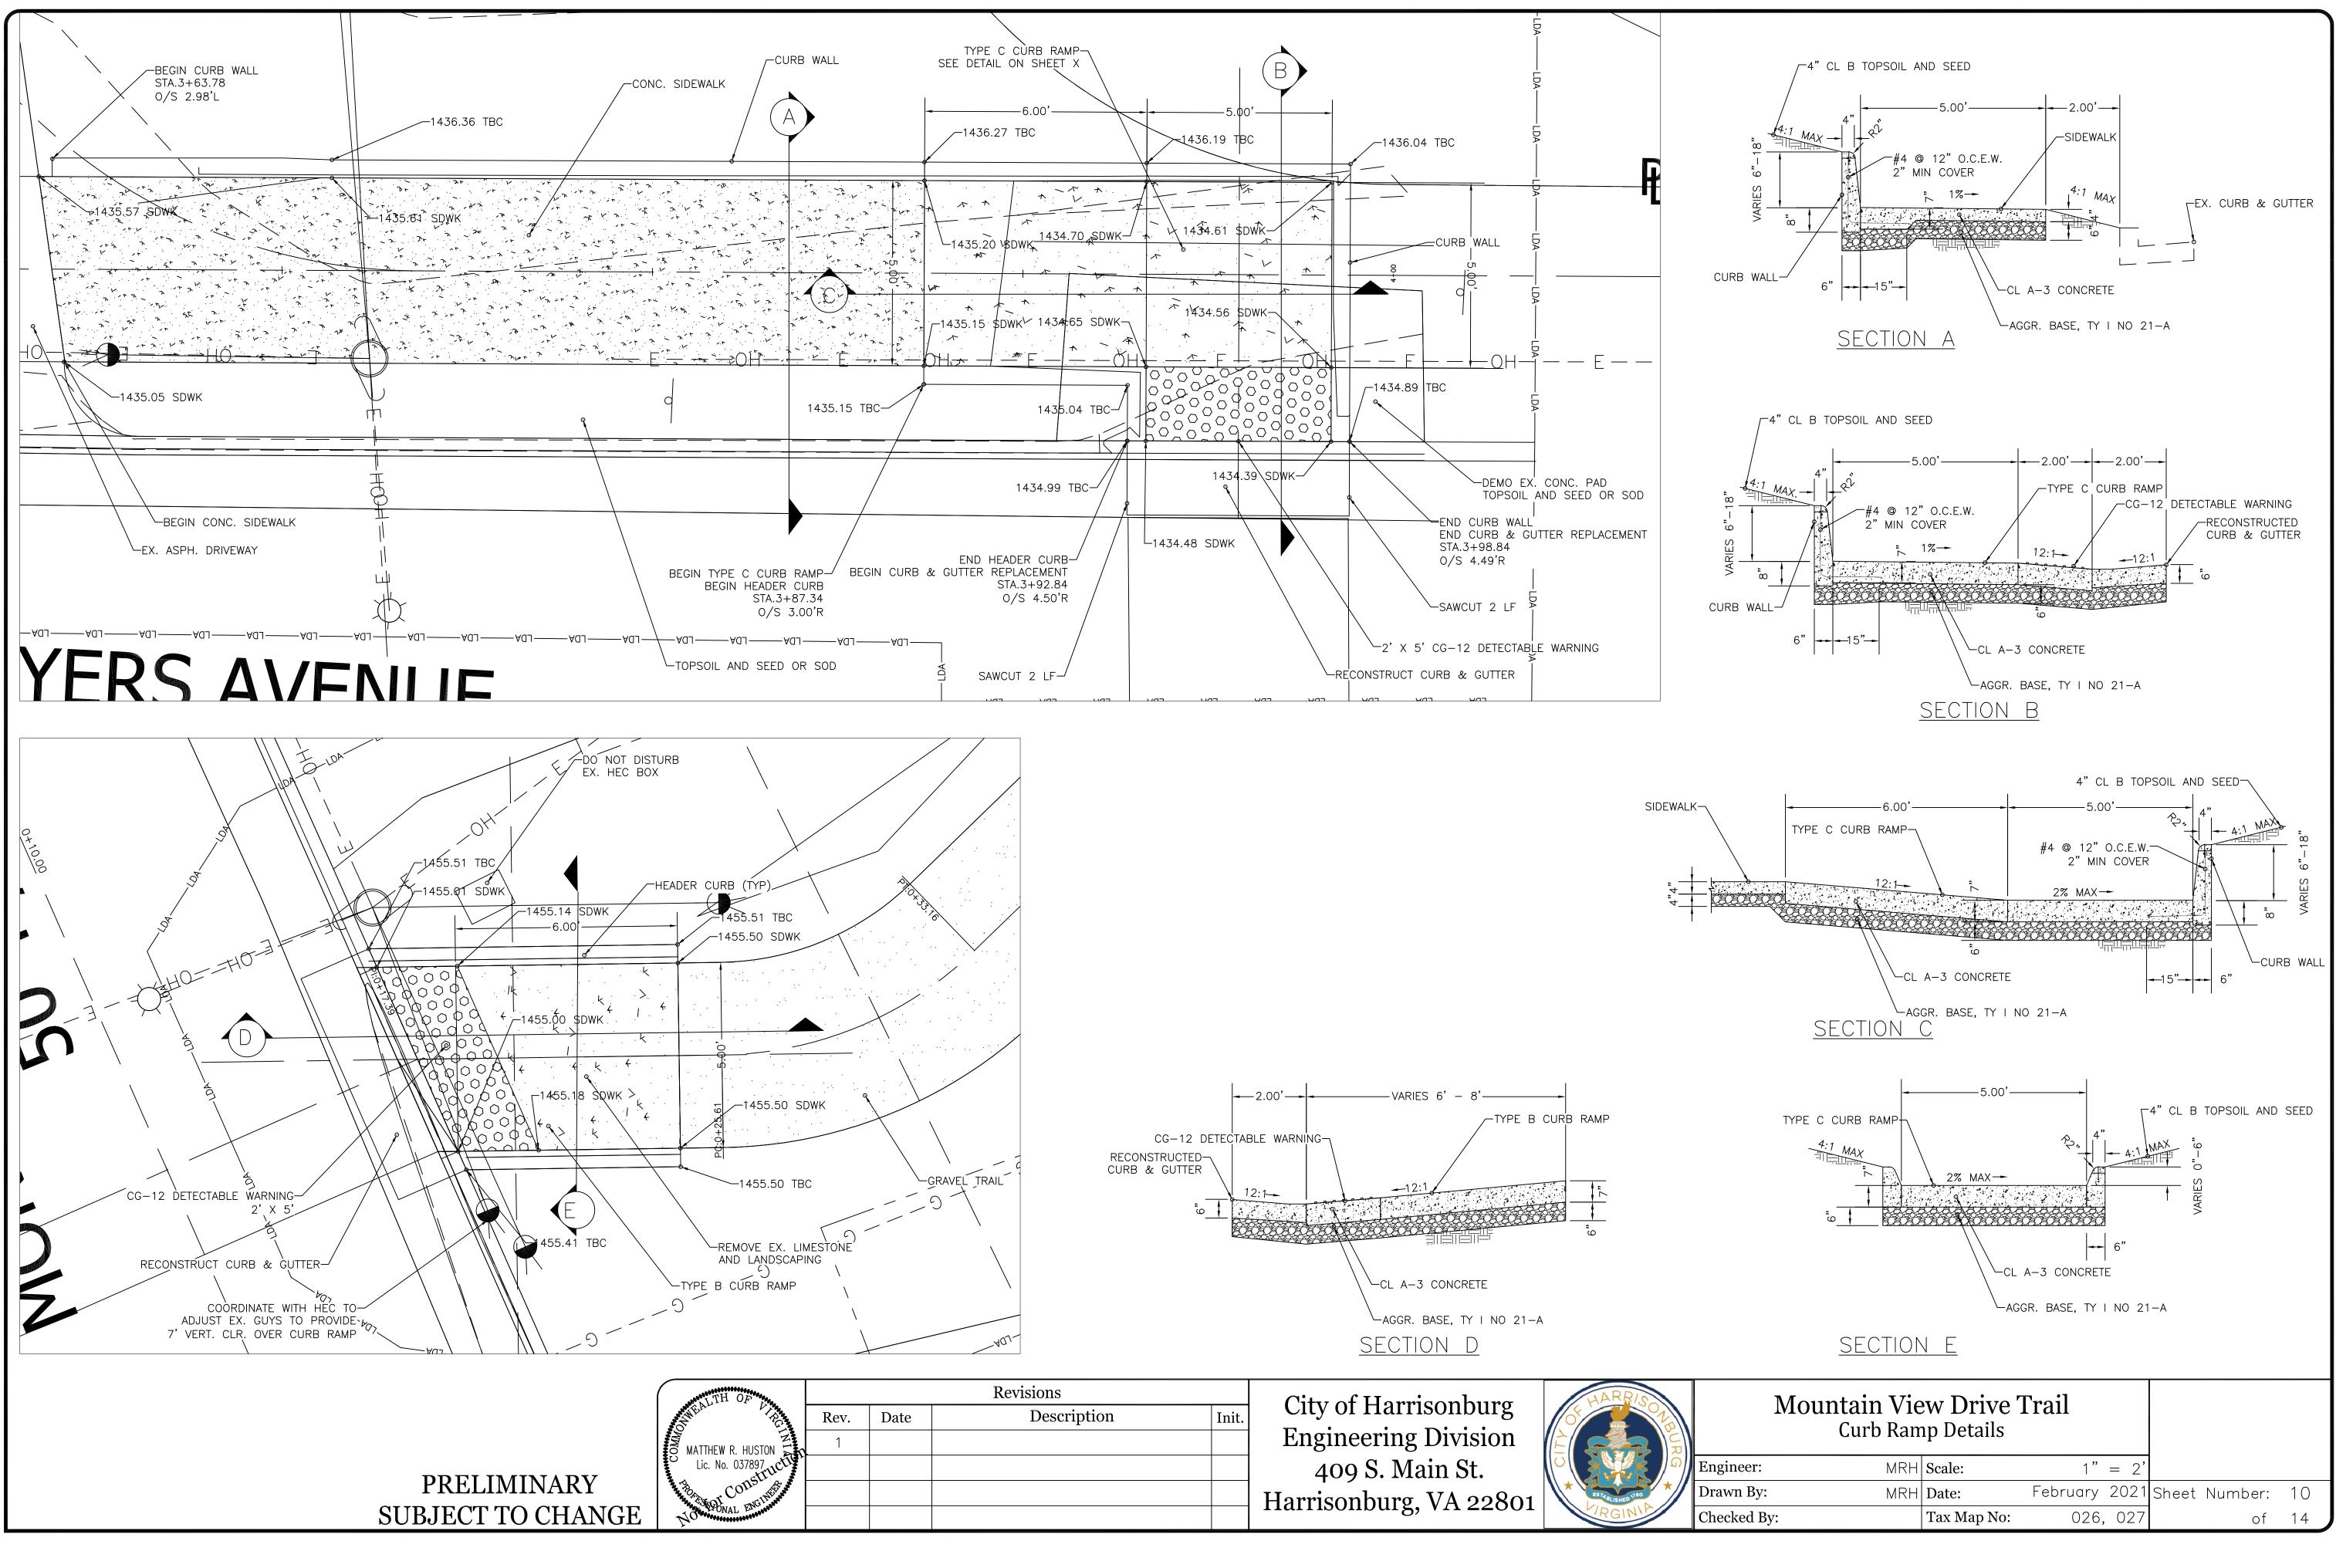


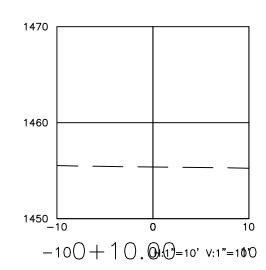


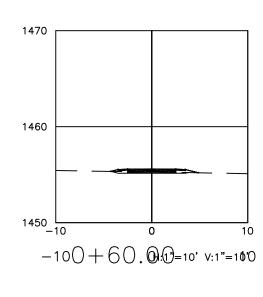

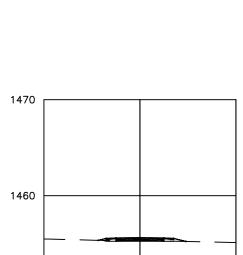





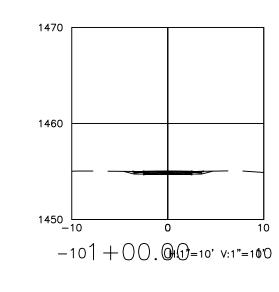


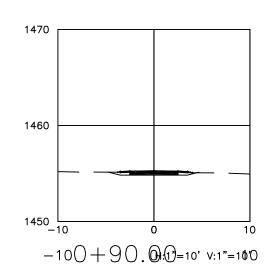





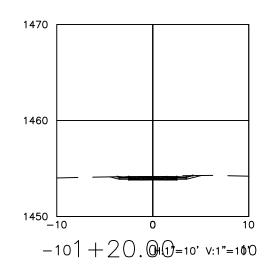

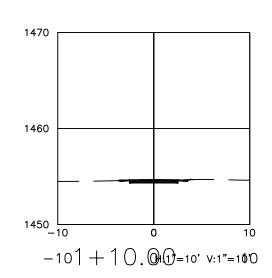


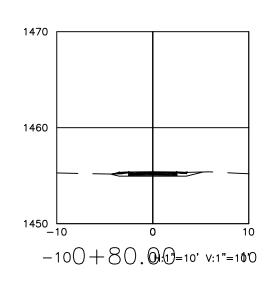


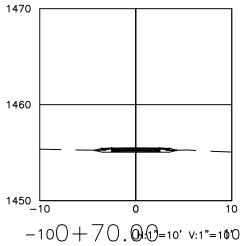

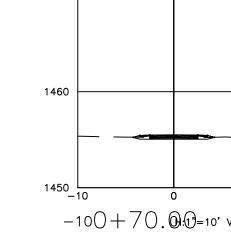




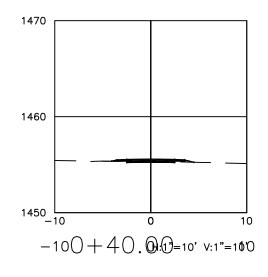


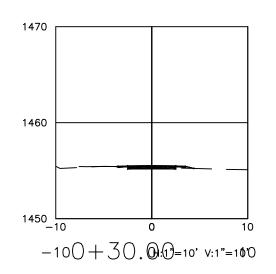



City of Harrisonburg Engineering Division 409 S. Main St. Harrisonburg, VA 22801

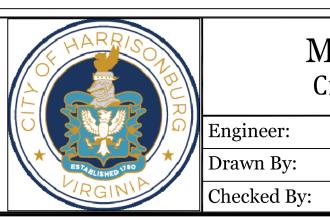



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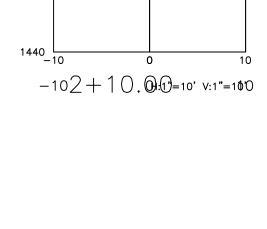


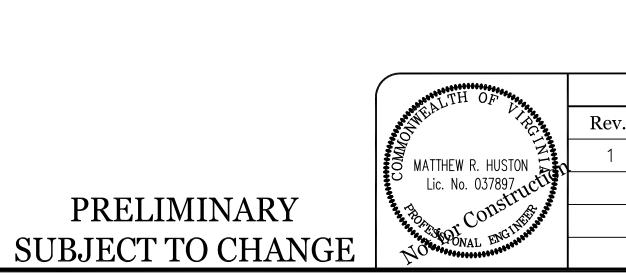


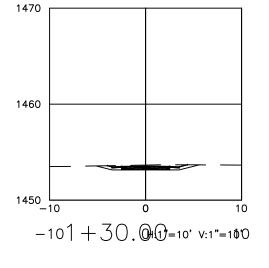

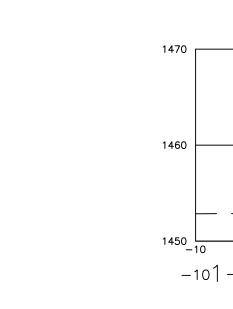


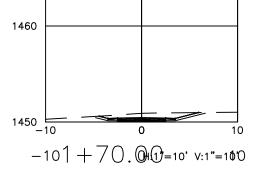


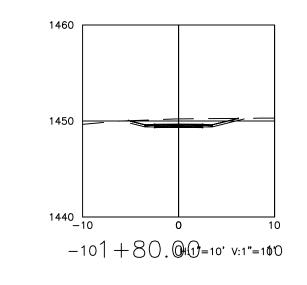


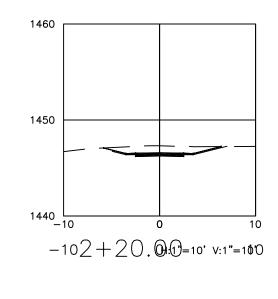



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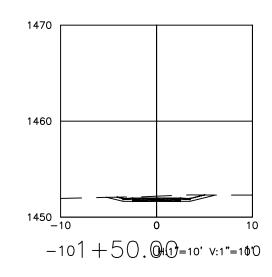


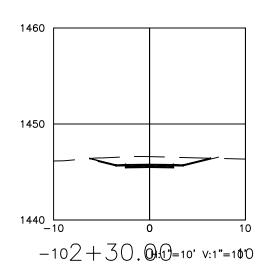


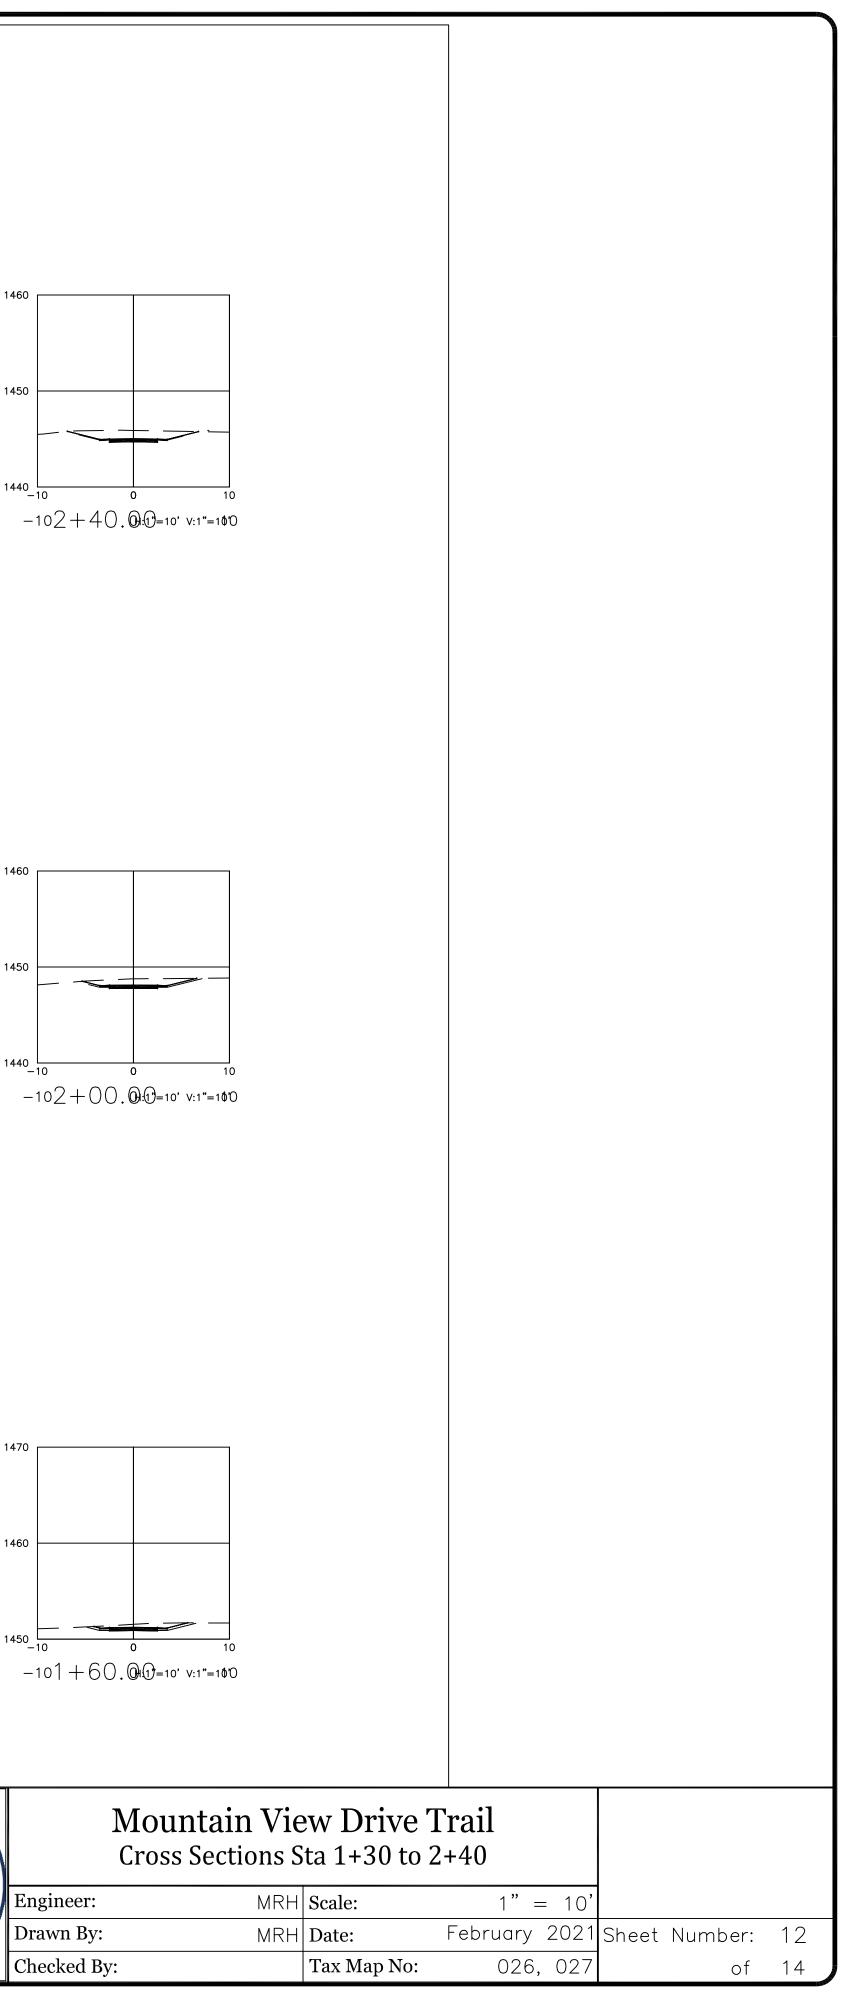

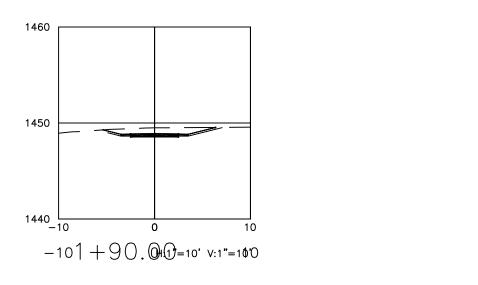

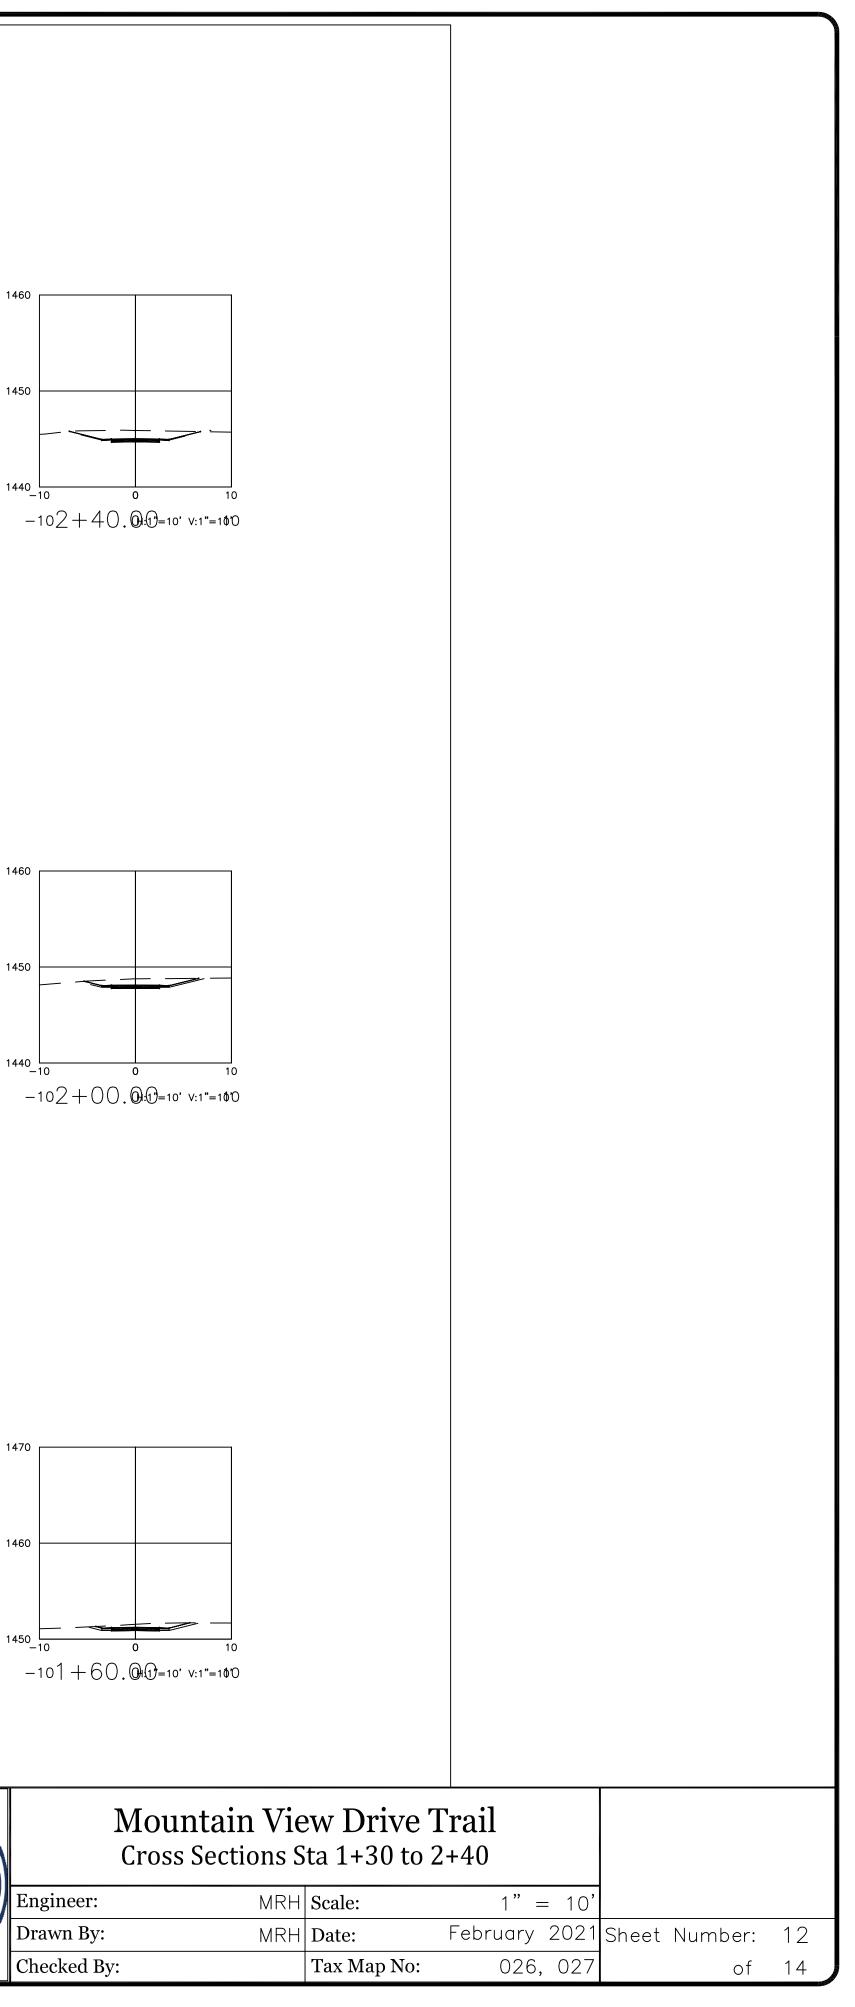


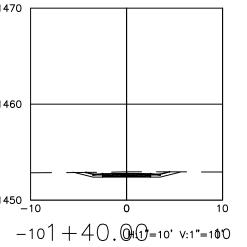


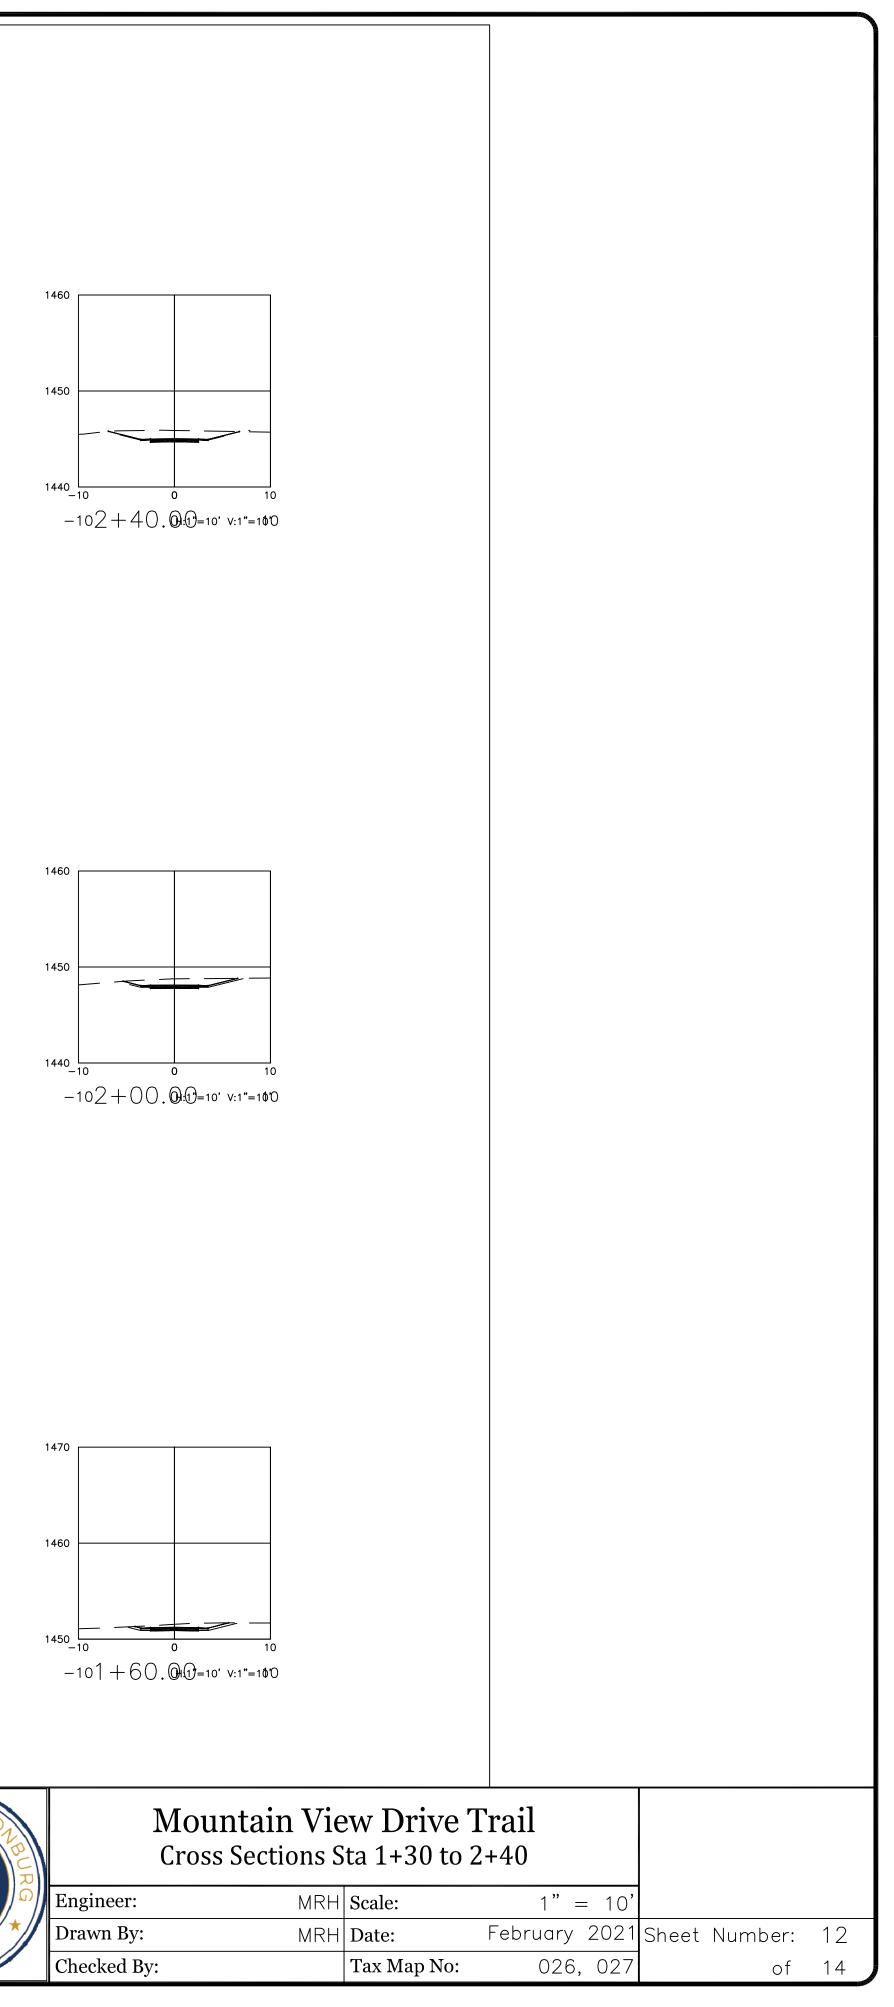



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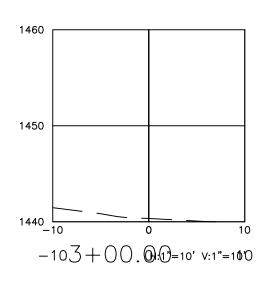





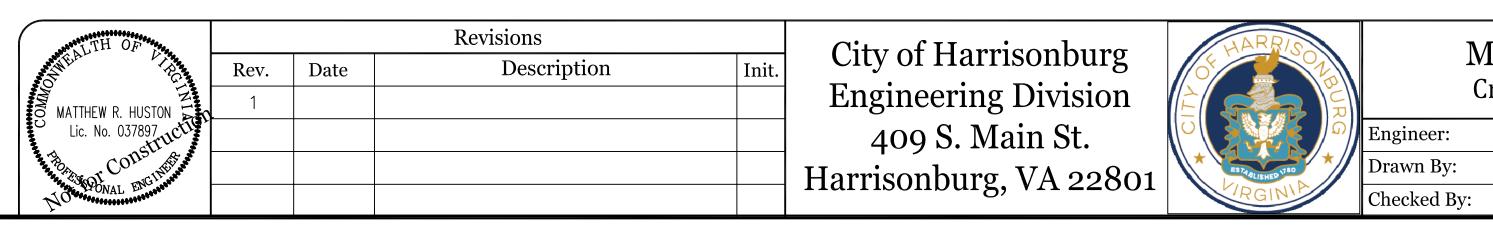


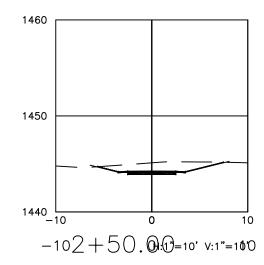


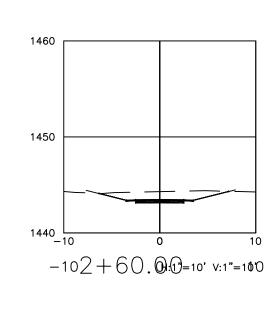


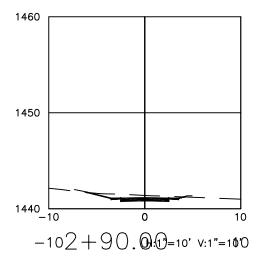


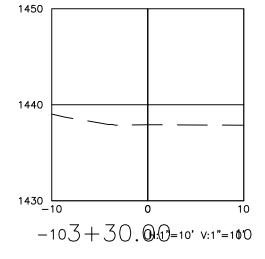


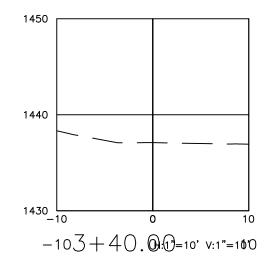


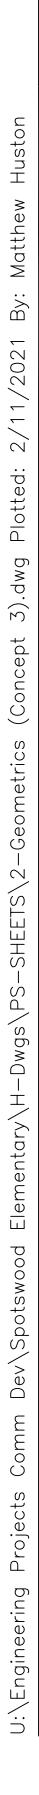


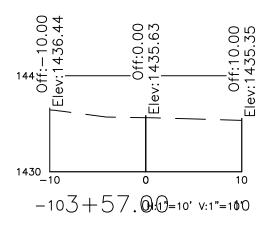


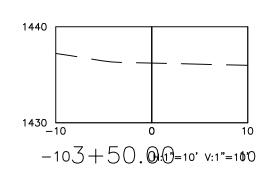

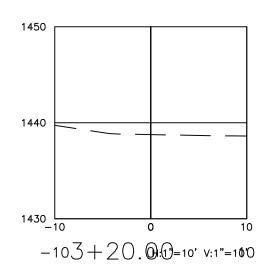


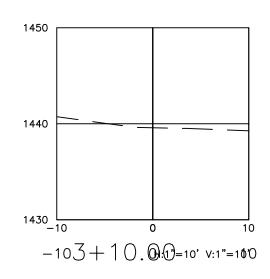


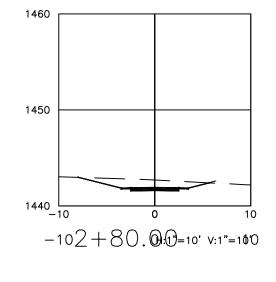


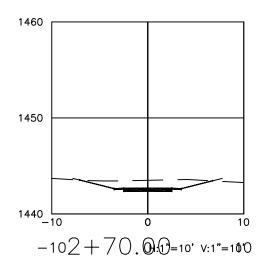



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MRH Sc		1" = 10'	-		
MRH Da		February 2021		Number:	13
Та	ax Map No:	026, 027	-	of	14

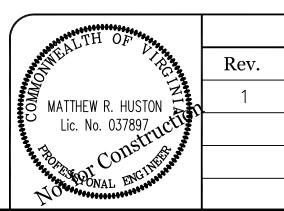

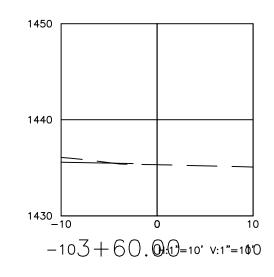

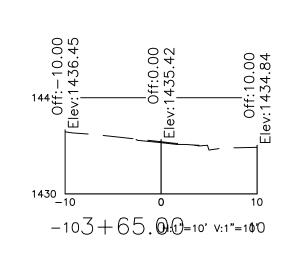


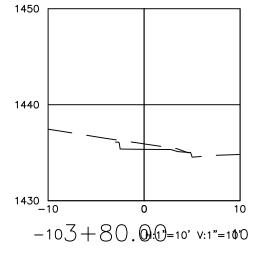


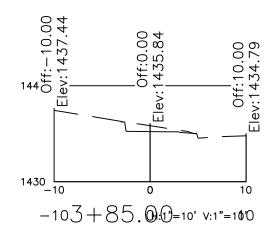






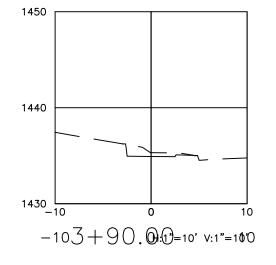

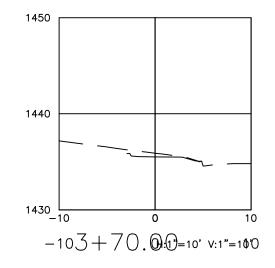

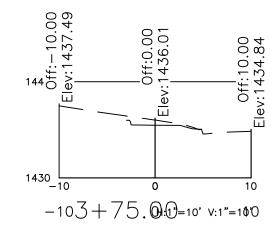

	Revisions		City of Upmicophyng	HARRISO	M
Date	Description	Init.	City of Harrisonburg	K C C	
			Engineering Division		Cr
			409 S. Main St.		Engineer:
			Harrisonburg, VA 22801	* ESTALISHED 150	Drawn By:
			11u1115011501150115, V11 22001	FIRGINIA	Checked By:

4.84	
Elev:1434.84	
0 10	
Mountain View Cross Sections Sta 3	
MRH Sca MRH Dat Tax	