

TURN LEFT ONTO RADY ST., 0.2 MILES TURN LEFT ONTO MAGNOLIA ST., 0.6 MILES TURN RIGHT ONTO MECHANICSVILLE TURNPIKE, 0.2 MILES MERGE ONTO 1-64 E, KEEP RIGHT, 99.5 MILES TAKE EXIT 87 FOR INTERSTATE 81 N, 24 MILES TAKE EXIT 245, 0.2 MILES TURN RIGHT ONTO VA-253 E/PORT REPUBLIC RD, 0.4 MILES ARRIVING AT DESTINATION ON RIGHT.

DIRECTIONS FROM SHOCKOE SWITCH (1831 RADY CT., RICHMOND, VA 23222):

## HARRISONBURG N001, N004, & N005

# 865 PORT REPUBLIC ROAD HARRISONBURG, VA 22801

E911 ADDRESS YES ⋈ NO □

PROJECT DESCRIPTION

INSTALLATION AND OPERATION OF A SMALL CELL NODE AND ASSOCIATED EQUIPMENT ON AN EXISTING BUILDING

UTILITIES INFO:

POWER: HARRISONBURG ELECTRIC
540.434.5361
TELEPHONE: VERIZON
855.579.3753



EMERGENCY INFO:

JURISDICTION:
HARRISONBURG
LOCAL FIRE AND RESCUE:
540.432.7703
LOCAL POLICE:

PROJECT TEAM						340.437.2002		
REAL ESTATE: ED GIVEN					PHONE NUMBER:	304.741.2336		
ZONING: JOSIE LODDER					PHONE NUMBER:	704.560.1422		
CONSTRUCTION: RICHARD ROSS					PHONE NUMBER:	504.903.0212		
JTILITIES: RICHARD ROSS					PHONE NUMBER:	504.903.0212		
REV. NO. DESCRIPTION	BY	DATE	REV.	NO.	DESCRIPTION		BY	DATE
0 FOR REVIEW	ККВ	03/06/17						
		-						

James Madison University	247A G
Cerrier Dr Que	
	University Blvd Valley
SITE LOCATION	De Haday
South Roy In Hell Fig.	Deviente Aive
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To the state of th	M

LOCAL MAP

China Express

N.T.S.

N.T.S.

Α	28	E	CONSULTING	TEAM
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ARCHITECTURE AND ENGINEERING:
DEWBERRY ENGINEERS INC.
4805 LAKE BROOK DRIVE, SUITE 200
GLEN ALLEN, VA 23060
PHONE 

■ 804.205.3337
CONTACT: DEREK MARSHALL, PE, LEED AP

STRUCTURAL ENGINEER:
DEWBERRY ENGINEERS INC.
133 GATHER DRIVE, SUITE F
MT. LAUREL, NJ 08054
PHONE # 856,780,3631
CONTACT: NICK BERTE, PE

### PROJECT SUMMARY

PROPERTY OWNER: 865 EAST LLC PO BOX 2037 HARRISONBURG VA 22803

PROJECT INFO:
LOCATION NAME: HARRISONBURG N001, N004, & N005

APPLICANT INFO: VERIZON WIRELESS 1831 RADY COURT RICHMOND, VA 23222 PHONE: 757.305.8420 CONTACT: NATHAN HOLLAND

PROJECT DATA:

ZONING: R-5C

PARCEL ID: 92 F 1

ACREAGE: 5.47

JURISDICTION: HARRISONBURG
SITE TYPE: ROOFTOP
SITE TYPE: SMALL CELL
STRUCTURE HEIGHT: 69.0'

AVIENNA RAD CENTER: 68.0'
LEASE AREA: 100 SF

AREA OF DISTURBANCE: 0 SF

CENTER OF PROPOSED ANTENNA\*: LATITUDE: 38' 25' 24.95" N LONGITUDE: 78' 52' 23.03" W ELEVATION: 1408' AMSL +PER GOOGLE EARTH

THIS DOCUMENT WAS DEVELOPED TO REFLECT A SPECIFIC SITE AND ITS SITE CONDITIONS AND IS NOT TO BE USED FOR ANOTHER SITE OR WHEN OTHER CONDITIONS PERTAIN. REUSE OF THIS DOCUMENT IS AT THE SOLE RISK OF THE USER.

A.D.A. COMPLIANCE: FACILITY IS UNMANNED AND NOT FOR HUMAN HABITATION

## INDEX OF DRAWINGS DESCRIPTION

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865 PORT REPUBLIC ROAD HARRISONBURG, VA 22801

SHEET TITLE

TITLE SHEET

SHEET NUMBER

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VERIZON WIRELESS 1831 RADY COURT

RICHMOND, VA 23222


HARRISONBURG N001, N004, & N005

C	ONSTRUC	TION	DRAWINGS
0	03/06/17	FOR C	ONSTRCUTION



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Glien Allen, VA 23030
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www.dewberry.com

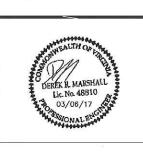

DRAWN BY:	MAF
REVIEWED BY:	DRM
CHECKED BY:	DRM
PROJECT NUMBER:	50075169

### GENERAL CONSTRUCTION NOTES:

- THE CONTRACTOR SHALL VISIT THE JOB SITE PRIOR TO THE SUBMISSION OF BIDS OR PERFORMING WORK IN ORDER TO BECOME FAMILIARIZE WITH THE FIELD CONDITIONS AND TO VERIFY THAT THE PROJECT CAN BE CONSTRUCTED IN ACCORDANCE WITH THE CONTRACT DOCUMENTS.
- CONTRACTOR SHALL CONTACT "MISS UTILITY" (1-800-552-7001) FOR IDENTIFICATION OF UNDERGROUND UTILITIES PRIOR TO START OF CONSTRUCTION.
- 3. CONTRACTOR IS RESPONSIBLE FOR COORDINATING ALL REQUIRED INSPECTIONS.
- 4. ALL DIMENSIONS TO, OF, AND ON EXISTING BUILDINGS, DRAINAGE STRUCTURES, AND SITE IMPROVEMENTS SHALL BE VERIFIED IN FIELD BY CONTRACTOR WITH ALL DISCREPANCIES REPORTED TO THE ENGINEER.
- 5. DO NOT CHANGE SIZE OR SPACING OF STRUCTURAL ELEMENTS.
- 6. DETAILS SHOWN ARE TYPICAL; SIMILAR DETAILS APPLY TO SIMILAR CONDITIONS UNLESS OTHERWISE NOTED.
- THESE DRAWINGS DO NOT INCLUDE NECESSARY COMPONENTS FOR CONSTRUCTION SAFETY WHICH IS THE SOLE RESPONSIBILITY OF THE CONTRACTOR.
- CONTRACTOR SHALL BRACE STRUCTURES UNTIL ALL STRUCTURAL ELEMENTS NEEDED FOR STABILITY ARE INSTALLED.
  THESE ELEMENTS ARE AS FOLLOWS: LATERAL BRACING, ANCHOR BOLTS, ETC.
- CONTRACTOR SHALL DETERMINE EXACT LOCATION OF EXISTING UTILITIES, DRAIN PIPES, VENTS, ETC. BEFORE COMMENCING WORK,
- 10. INCORRECTLY FABRICATED, DAMAGED, OR OTHERWISE MISFITTING OR NONCONFORMING MATERIALS OR CONDITIONS SHALL BE REPORTED TO THE OWNER PRIOR TO REMEDIAL OR CORRECTIVE ACTION. ANY SUCH REMEDIAL ACTION SHALL REQUIRE WRITTEN APPROVAL BY THE OWNER'S REPRESENTATIVE PRIOR TO PROCEEDING.
- EACH CONTRACTOR SHALL COOPERATE WITH THE OWNER'S REPRESENTATIVE, AND COORDINATE HIS WORK WITH THE WORK OF OTHERS.
- CONTRACTOR SHALL REPAIR ANY DAMAGE CAUSED BY CONSTRUCTION OF THIS PROJECT TO MATCH EXISTING PRE-CONSTRUCTION CONDITIONS TO THE SATISFACTION OF THE VERIZON WIRELESS CONSTRUCTION MANAGER.
- 13. ALL CABLE/CONDUIT ENTRY/EXIT PORTS SHALL BE WEATHERPROOFED DURING INSTALLATION USING A SILICONE SEALANT
- 14. WHERE EXISTING CONDITIONS DO NOT MATCH THOSE SHOWN IN THIS PLAN SET, CONTRACTOR WILL NOTIFY ENGINEER, CONSTRUCTION MANAGER, AND LANDLORD IMMEDIATELY.
- 15. CONTRACTOR SHALL ENSURE ALL SUBCONTRACTORS ARE PROVIDED WITH A CURRENT SET OF DRAWINGS AND SPECIFICATIONS FOR THIS PROJECT.
- ALL ROOF WORK SHALL BE DONE BY A QUALIFIED AND EXPERIENCED ROOFING CONTRACTOR IN COORDINATION WITH ANY CONTRACTOR WARRANTING THE ROOF TO ENSURE THAT THE WARRANTY IS MAINTAINED.
- 17. CONTRACTOR SHALL REMOVE ALL RUBBISH AND DEBRIS FROM THE SITE AT THE END OF EACH DAY.
- 18. CONTRACTOR SHALL COORDINATE WORK SCHEDULE WITH LANDLORD AND TAKE PRECAUTIONS TO MINIMIZE IMPACT AND DISRUPTION OF OTHER OCCUPANTS OF THE FACILITY.
- 19. CONTRACTOR SHALL FURNISH THE CARRIER WITH THREE AS-BUILT SETS OF DRAWINGS UPON COMPLETION OF WORK
- 20. ANTENNAS AND CABLES ARE TYPICALLY PROVIDED BY VERIZON WIRELESS. PRIOR TO SUBMISSION OF BID, CONTRACTOR SHALL COORDINATE WITH VERIZON WIRELESS PROJECT MANAGER TO DETERMINE WHAT, IF ANY, ITEMS WILL BE PROVIDED BY VERIZON WIRELESS, ALL ITEMS NOT PROVIDED BY VERIZON WIRELESS SHALL BE PROVIDED AND INSTALLED BY THE CONTRACTOR. CONTRACTOR WILL INSTALL ALL ITEMS PROVIDED BY VERIZON WIRELESS.
- 21. PRIOR TO SUBMISSION OF BID, CONTRACTOR WILL COORDINATE WITH VERIZON WIRELESS PROJECT MANAGER TO DETERMINE IF ANY PERMITS WILL BE OBTAINED BY VERIZON WIRELESS. ALL REQUIRED PERMITS NOT OBTAINED BY VERIZON WIRELESS MUST BE OBTAINED, AND PAID FOR, BY THE CONTRACTOR.
- 22. IF APPLICABLE, THE GENERAL CONTRACTOR SHALL HAVE A LICENSED HVAC CONTRACTOR START THE HVAC UNITS, SYNCHRONIZE THE THERMOSTATS, ADJUST ALL SETTINGS ON EACH UNIT ACCORDING TO VERIZON WIRELESS CONSTRUCTION MANAGER'S SPECIFICATIONS, AND THOROUGHLY TEST AND BALANCE EACH UNIT TO ENSURE PROPER OPERATION PRIOR TO TURNING THE SITE OVER TO OWNER.
- 23. CONTRACTOR SHALL SUBMIT ALL SHOP DRAWINGS TO ENGINEER FOR REVIEW AND APPROVAL PRIOR TO FARRICATION.
- 24. ALL EQUIPMENT SHALL BE INSTALLED ACCORDING TO MANUFACTURER'S SPECIFICATIONS AND LOCATED ACCORDING TO VERIZON WIRELESS SPECIFICATIONS, AND AS SHOWN IN THESE PLANS.
- 25. CONTRACTOR SHALL NOTIFY THE ENGINEER A MINIMUM OF 48 HOURS IN ADVANCE PRIOR TO CONSTRUCTION START, MORE SPECIFICALLY BEFORE; SEALING ANY FLOOR, WALL OR ROOF PENETRATION, FINAL UTILITY CONNECTIONS, POURING CONCRETE, BACKFILLING UTILITY TRENCHES AND STRUCTURAL POST OR MOUNTING CONNECTIONS, FOR ENGINEERING REVIEW AND INSPECTION.
- 26. CONTRACTOR SHALL BE RESPONSIBLE FOR SITE SAFETY INCLUDING COMPLIANCE WITH ALL APPLICABLE OSHA STANDARDS AND RECOMMENDATIONS AND SHALL PROVIDE ALL NECESSARY SAFETY DEVICES INCLUDING PPE AND PPM AND CONSTRUCTION DEVICES SUCH AS WELDING AND FIRE PREVENTION, TEMPORARY SHORING, SCAFFOLDING, TRENCH BOXES/SLOPING, BARRIERS, ETC.
- 27. DETECTION WIRE SHALL BE BURIED DIRECTLY ABOVE NON-METALLIC PIPING AT A DISTANCE NOT TO EXCEED TWELVE (12) INCHES ABOVE THE TOP OF PIPE. THE WIRE SHALL EXTEND CONTINUOUSLY AND UNBROKEN FROM POINT OF ACCESS TO POINT OF ACCESS. THE ENDS OF THE WIRE SHALL TERMINATE WITH A MINIMUM OF THREE (3) FEET OF WIRE, COILED, REMAINING ACCESSIBLE AT TERMINATION POINTS. DETECTION WIRE SHALL BE 12 GAUGE FOR A BURIED DEPTH OF LESS THAN 4 FEET AND 4 GAUGE FOR A BURIED DEPTH GREATER THAN OR EQUAL TO 4 FEET.
- 28. THE CONTRACTOR SHALL GIVE ALL NOTICES AND REGULATIONS AND LAWFUL ORDERS OF ANY PUBLIC AUTHORITY.
  MUNICIPAL AND UTILITY COMPANY SPECIFICATIONS, AND LOCAL AND STATE JURISDICTIONAL CODES BEARING ON THE
  PERFORMANCE OF THE WORK. THE WORK PERFORMED ON THE PROJECT AND THE MATERIALS INSTALLED SHALL
  BE IN STRICT ACCORDANCE WITH ALL APPLICABLE CODES, REGULATIONS, AND ORDINANCES.
- 29. THE CONTRACTOR OR BIDDER SHALL BEAR THE RESPONSIBILITY OF NOTIFYING (IN WRITING) THE CONSTRUCTION MANAGER OF ANY CONFLICTS, ERRORS OR OMISSIONS PRIOR TO THE SUBMISSION OF CONTRACTOR'S PROPOSAL OR PERFORMANCE OF WORK. IN THE EVENT OF DISCREPANCIES, THE CONTRACTOR SHALL PRICE THE MORE COSTLY OR EXTENSIVE WORK, UNLESS DIRECTED IN WRITING OTHERWISE.
- 30. THE SCOPE OF WORK SHALL INCLUDE FURNISHING ALL MATERIALS, EQUIPMENT, LABOR AND ALL OTHER MATERIALS AND LABOR DEEMED NECESSARY TO COMPLETE THE WORK/PROJECT AS DESCRIBED HEREIN.
- 31. THE CONTRACTOR SHALL OBTAIN AUTHORIZATION TO PROCEED WITH CONSTRUCTION PRIOR TO STARTING WORK ON ANY ITEM NOT CLEARLY DEFINED BY THE CONSTRUCTION DRAWINGS/CONTRACT DOCUMENTS.
- 32. THE CONTRACTOR SHALL INSTALL ALL EQUIPMENT AND MATERIALS ACCORDING TO THE MANUFACTURER'S/VENDORS SPECIFICATIONS UNLESS OTHERWISE OR WHERE LOCAL CODES OR ORDINANCES TAKE PRECEDENCE.
- 33. THE CONTRACTOR SHALL PROVIDE A FULL SET OF CONSTRUCTION DOCUMENTS AT THE SITE UPDATED WITH THE LATEST REVISIONS AND ADDENDUMS OR CLARIFICATIONS AVAILABLE FOR THE USE BY ALL PERSONNEL INVOLVED WITH THE PROJECT.

- 34. THE CONTRACTOR SHALL SUPERVISE AND DIRECT THE PROJECT DESCRIBED HEREIN. THE CONTRACTOR SHALL BE SOLELY RESPONSIBLE FOR ALL THE CONSTRUCTION MEANS, METHODS, TECHNIQUES, SEQUENCES AND PROCEDURES AND FOR COORDINATING ALL PORTIONS OF THE WORK UNDER THE CONTRACT.
- 35. THE CONTRACTOR SHALL BE RESPONSIBLE FOR OBTAINING ALL PERMITS AND INSPECTIONS WHICH MAY BE REQUIRED FOR THE WORK BY THE ARCHITECT/ENGINEER, THE STATE, COUNTY OR LOCAL GOVERNMENT AUTHORITY.
- 36. THE CONTRACTOR SHALL MAKE NECESSARY PROVISIONS TO PROTECT EXISTING IMPROVEMENTS, EASEMENTS, PAVEMENTS, CURBING, ETC. DURING CONSTRUCTION. UPON COMPLETION OF WORK, THE CONTRACTOR SHALL REPAIR ANY DAMAGE THAT MAY HAVE OCCURRED DUE TO CONSTRUCTION ON OR ABOUT THE PROPERTY.
- 37. THE CONTRACTOR SHALL MAINTAIN THE GENERAL WORK AREA AS CLEAN AND HAZARD FREE DURING CONSTRUCTION AND DISPOSE OF ALL DIRT, DEBRIS, RUBBISH AND REMOVE EQUIPMENT NOT SPECIFIED AS REMAINING ON THE PROPERTY. PREMISES SHALL BE LEFT IN CLEAN CONDITION AND FREE FROM PAINT SPOTS, DUST, OR SMUDGES OF ANY NATURE.
- 38. THE CONTRACTOR SHALL COMPLY WITH ALL OSHA REQUIREMENTS AS THEY APPLY TO THIS PROJECT.
- 39. THE CONTRACTOR SHALL NOTIFY THE CONSTRUCTION MANAGER WHERE A CONFLICT OCCURS ON ANY OF THE CONTRACT DOCUMENTS. THE CONTRACTOR IS NOT TO ORDER MATERIAL OR CONSTRUCT ANY PORTION OF THE WORK THAT IS IN CONFLICT UNTIL CONFLICT IS RESOLVED BY THE CONSTRUCTION MANAGER.
- 40. EROSION CONTROL MEASURES SHALL BE IN CONFORMANCE WITH THE LOCAL GUIDELINES FOR EROSION AND SEDIMENT CONTROL.
- 41. ALL CONSTRUCTION AND DESIGN FOR THE PROPOSED ANTENNA MOUNTS SHALL CONFORM IN ACCORDANCE WITH THE CURRENT STRUCTURAL STANDARDS FOR STEEL ANTENNA TOWERS AND ANTENNA SUPPORTING STRUCTURES.
- 42. CONTRACTOR TO VERIFY ANTENNA ELEVATION AND AZIMUTH WITH RF ENGINEERING PRIOR TO INSTALLATION.
- 43. THE CONTRACTOR SHALL POST ALL SIGNS REQUIRED BY THE LATEST VERSION OF THE VERIZON WIRELESS "RADIO FREQUENCY COMPLIANCE SIGNAGE & DEMARCATION POLICY" THIS MAY INCLUDE BUT ARE NOT LIMITED TOO:
  - A. <u>NOTICE SIGNS</u> TO DISTINGUISH THE BOUNDARY BETWEEN GENERAL POPULATION/UNCONTROLLED AREAS AND OCCUPATIONAL AREAS
  - B. <u>CAUTION\_SIGNS</u> TO DISTINGUISH THE CONTROLLED AREAS WHERE RADIO FREQUENCY (RF) EXPOSURE CAN EXCEED THE OCCUPATIONAL/CONTROLLED MAXIMUM PERMISSIBLE EXPOSURE (MPE) LIMIT.
  - C. <u>WARNING SIGNS</u> TO DISTINGUISH THE BOUNDARY OF AREAS WITH RF LEVELS SUBSTANTIALLY ABOVE THE FCC LIMITS, GREATER THAN TEN (10) TIMES THE OCCUPATIONAL/CONTROLLED MPE LIMIT.
  - D. NOTICE—GUIDELINES FOR WORKING IN RADIOFREQUENCY ENVIRONMENTS: THIS SIGN IS TO BE POSTED ANYTIME SIGNAGE IS REQUIRED TO ACHIEVE FCC COMPLIANCE. IT MUST BE POSTED ON EVERY ACCESS POINT WHERE VERIZON IS EXPECTED TO EXCEED THE FCC GENERAL POPULATION EXPOSURE LIMIT AND ON EVERY ANTENNA ARRAY IN ACCESSIBLE AREAS.



VERIZON WIRELESS 1831 RADY COURT RICHMOND, VA 23222


HARRISONBURG N001, N004, & N005

C	ONSTRUC	TION DRAWINGS
0	03/06/17	FOR CONSTRCUTION



Dewberry Engineers Inc.

4805 Lake Brook Drive, Suite 200 Glen Allen, VA 23060 Phone: 804,230,7957 Fax: 804,230,7928 www.dswberry.com

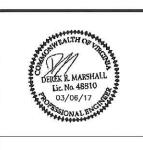

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REVIEWED BY:	DRM	
CHECKED BY:	DRM	
PROJECT NUMBER:	50075169	

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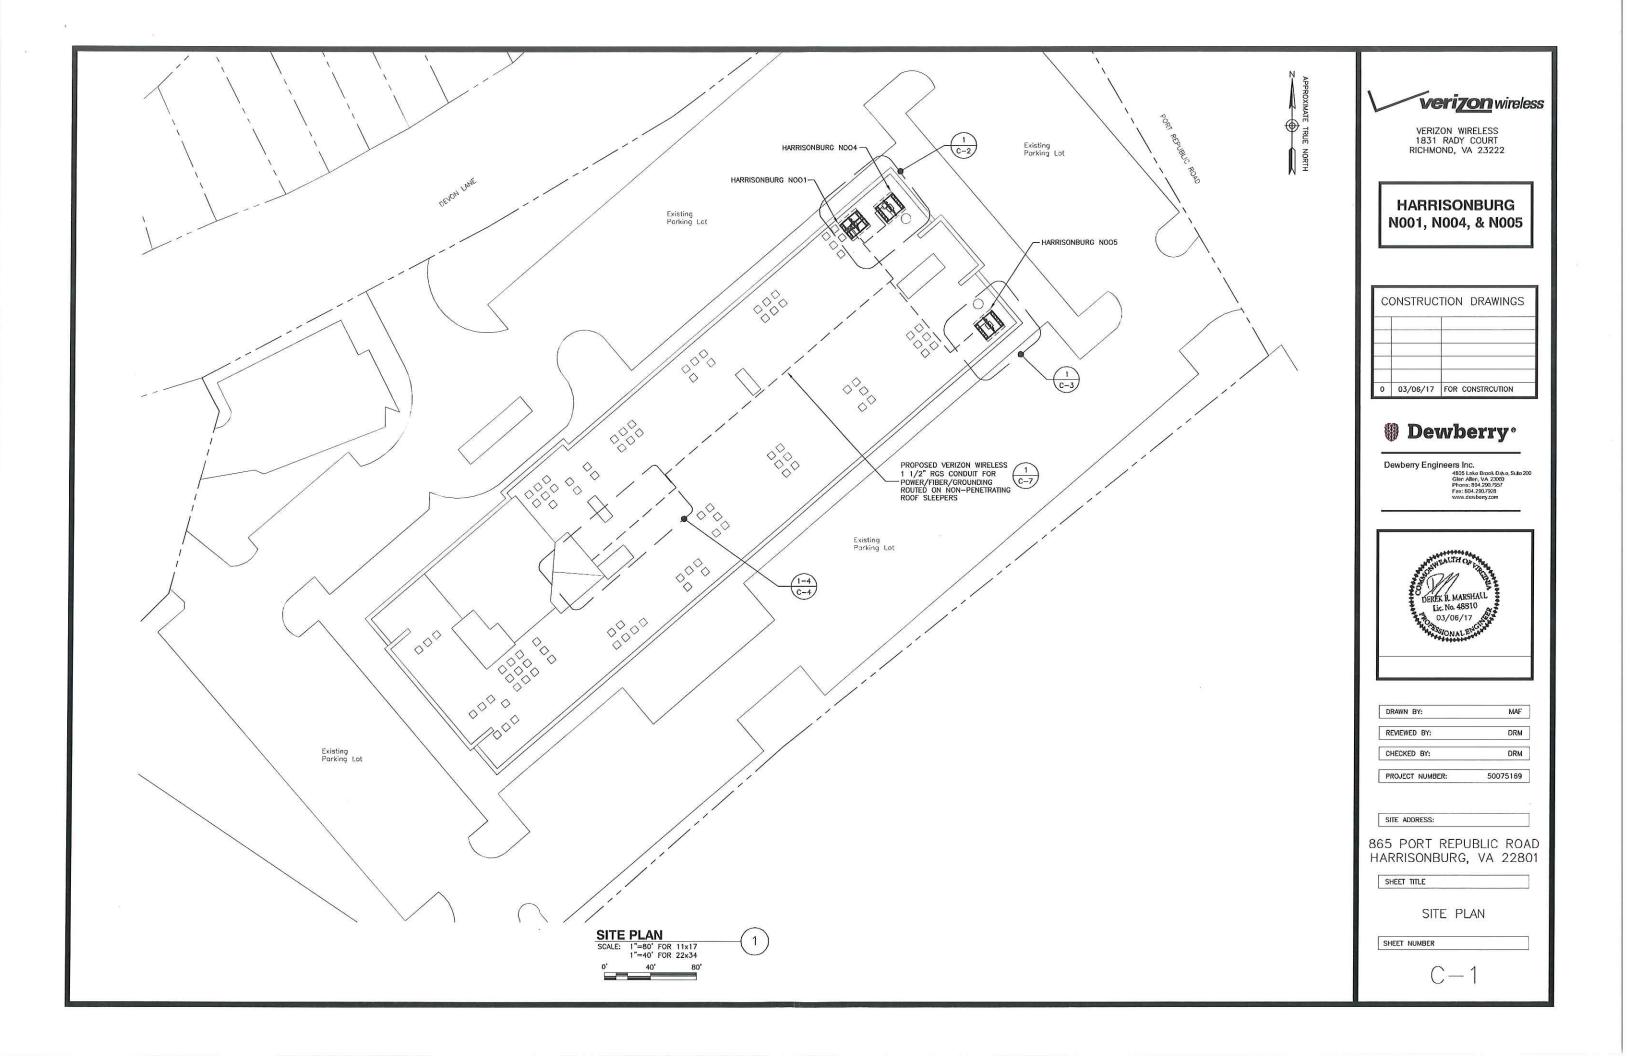
865 PORT REPUBLIC ROAD HARRISONBURG, VA 22801

SHEET TITLE

GENERAL NOTES

SHEET NUMBER


G-1



PRIOR TO BEGINNING CONSTRUCTION CONTRACTOR SHALL REFER TO STRUCTURAL ANALYSIS TITLED HARRISONBURG NOO1 COMPLETED BY DEWBERRY ENGINEERS INC. DATED, FEBRUARY 2, 2017.

PRIOR TO BEGINNING CONSTRUCTION CONTRACTOR SHALL REFER TO STRUCTURAL ANALYSIS TITLED HARRISONBURG NOD4 COMPLETED BY DEWBERRY ENGINEERS INC. DATED, FEBRUARY 1, 2016.



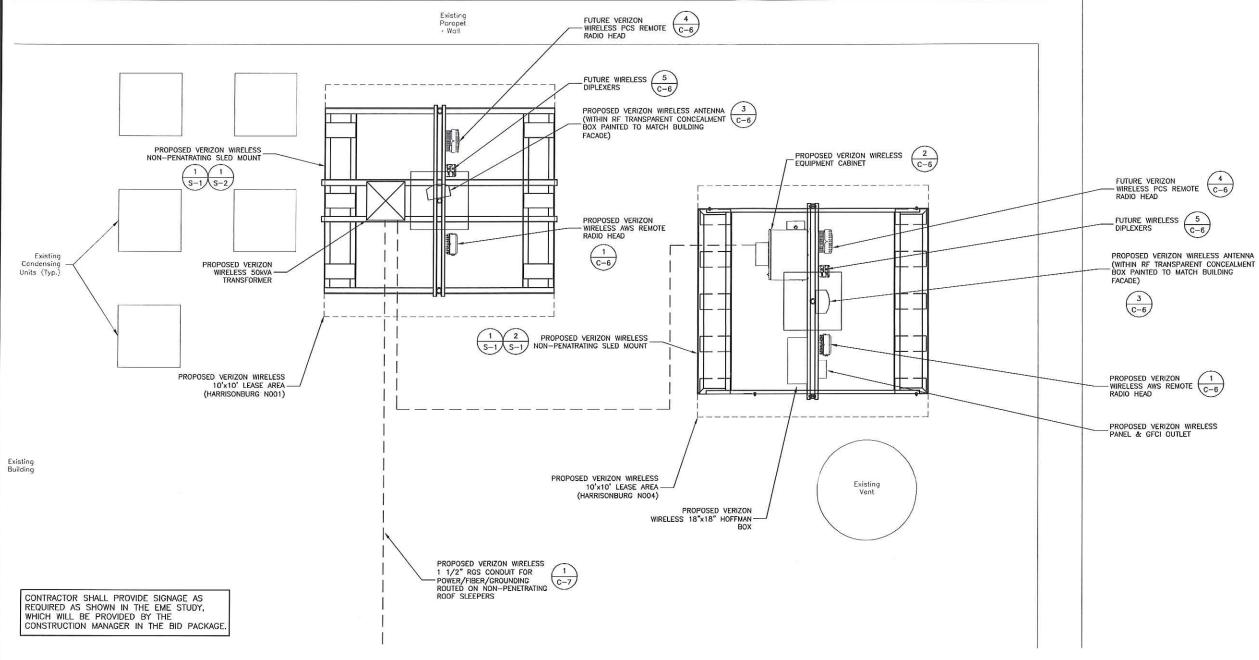

#### GENERAL NOTES

- 1. THE HOFFMAN FIBER BOX SHOULD BE LOCKED WITH COMBO LOCKS.
  2. USE WEATHER TIGHT CONNECTIONS FOR ALL CONDUITS CONNECTING TO EQUIPMENT.
  3. THE ALARM CABLING SHOULD BE PLACED INSIDE A LIQUID TIGHT CONDUIT AND USE ITS OWN KNOCK-OUT TO EMIER THE EQUIPMENT CABINET.
  4. CONTRACTOR TO MAKE SURE THAT THE EQUIPMENT IS INSTALLED WITHIN THE PROPOSED LEASE AREA.
  5. ALL CONDUITS AND COAX SHOULD BE SECURELY FASTENED TO THE UNISTRUT, H-FRAME OR SLED MOUNT.

- H FRAME OR SLED MOUNT.

  A LARM CONDUIT MUST END WITHIN 6" OF RRH PORT.

  SOME EXISTING & PROPOSED INFORMATION NOT SHOWN FOR CLARITY.

  ANTENNA, EQUIPMENT, AND EASEMENTS SUBJECT TO CHANGE.






VERIZON WIRELESS 1831 RADY COURT RICHMOND, VA 23222

**HARRISONBURG** N001, N004, & N005

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### Dewberry\*

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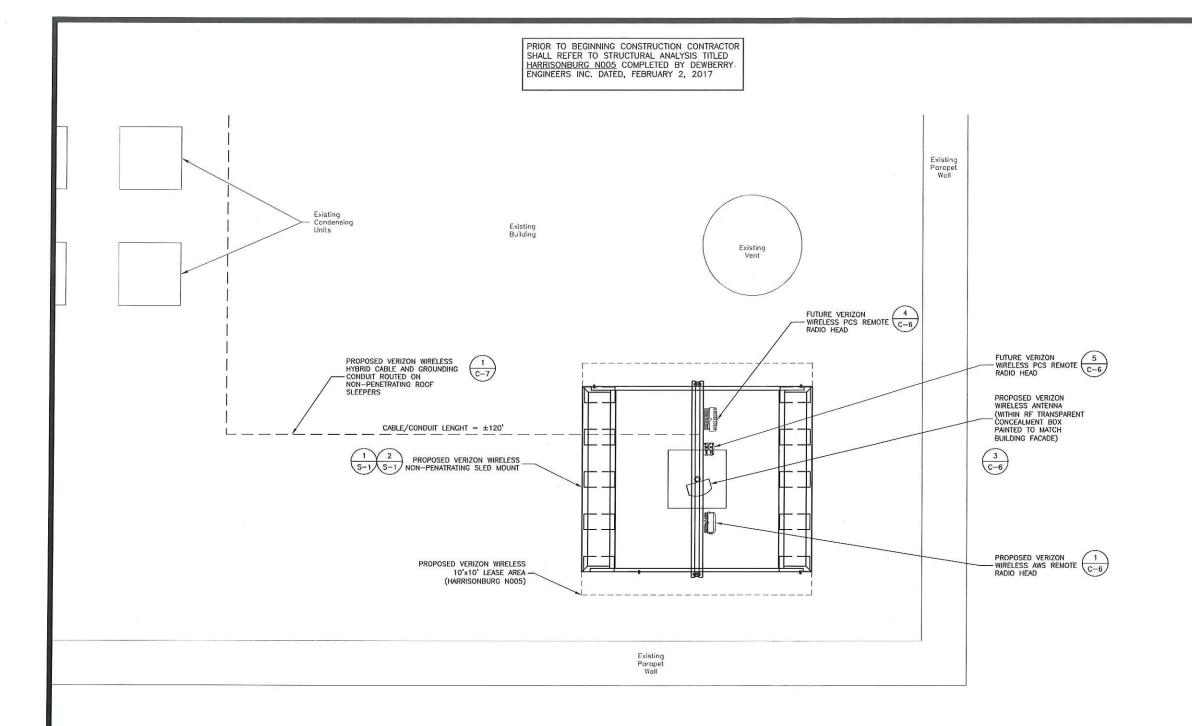
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865 PORT REPUBLIC ROAD HARRISONBURG, VA 22801

SHEET TITLE

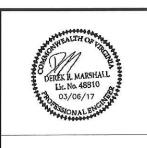ROOF PLAN

SHEET NUMBER



### GENERAL NOTES

- 1. THE HOFFMAN FIBER BOX SHOULD BE LOCKED WITH COMBO LOCKS.
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  4. CONTRACTOR TO MAKE SURE THAT THE EQUIPMENT IS INSTALLED WITHIN THE PROPOSED LEASE AREA.
  5. ALL CONDUITS AND COAX SHOULD BE SECURELY FASTENED TO THE UNISTRUT, H-FRAME OR SLED MOUNT.
  6. ALARM CONDUIT MUST END WITHIN 6" OF RRH PORT.
  7. SOME EXISTING & PROPOSED INFORMATION NOT SHOWN FOR CLARITY.
  8. ANTENNA, EQUIPMENT, AND EASEMENTS SUBJECT TO CHANGE.

CONTRACTOR SHALL PROVIDE SIGNAGE AS REQUIRED AS SHOWN IN THE EME STUDY, WHICH WILL BE PROVIDED BY THE CONSTRUCTION MANAGER IN THE BID PACKAGE.





VERIZON WIRELESS 1831 RADY COURT RICHMOND, VA 23222


**HARRISONBURG** N001, N004, & N005

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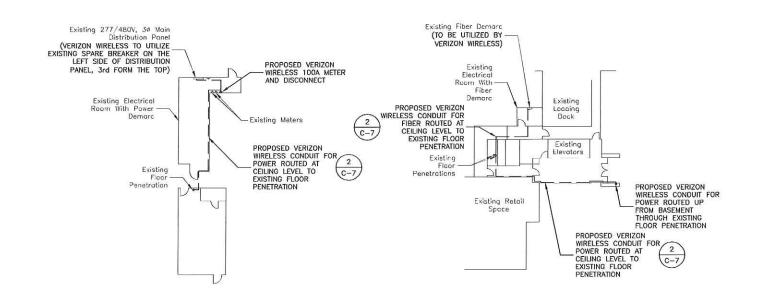
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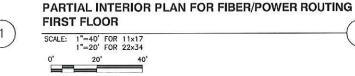
ROOF PLAN


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## PARTIAL BUILDING PLAN FOR POWER ROUTING BASEMENT SCALE: 1"=40' FOR 11x17 1"=20' FOR 22x34



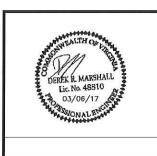

### PARTIAL INTERIOR PLAN FOR FIBER/POWER ROUTING FLOORS 2 - 6

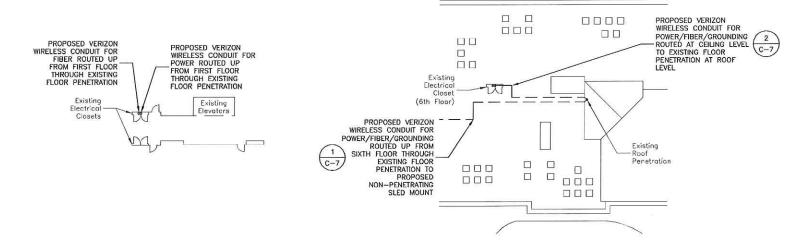

### PARTIAL INTERIOR PLAN FOR FIBER/POWER ROUTING FLOOR 6 - ROOF





1. SOME EXISTING & PROPOSED INFORMATION NOT SHOWN FOR CLARITY.



VERIZON WIRELESS 1831 RADY COURT RICHMOND, VA 23222


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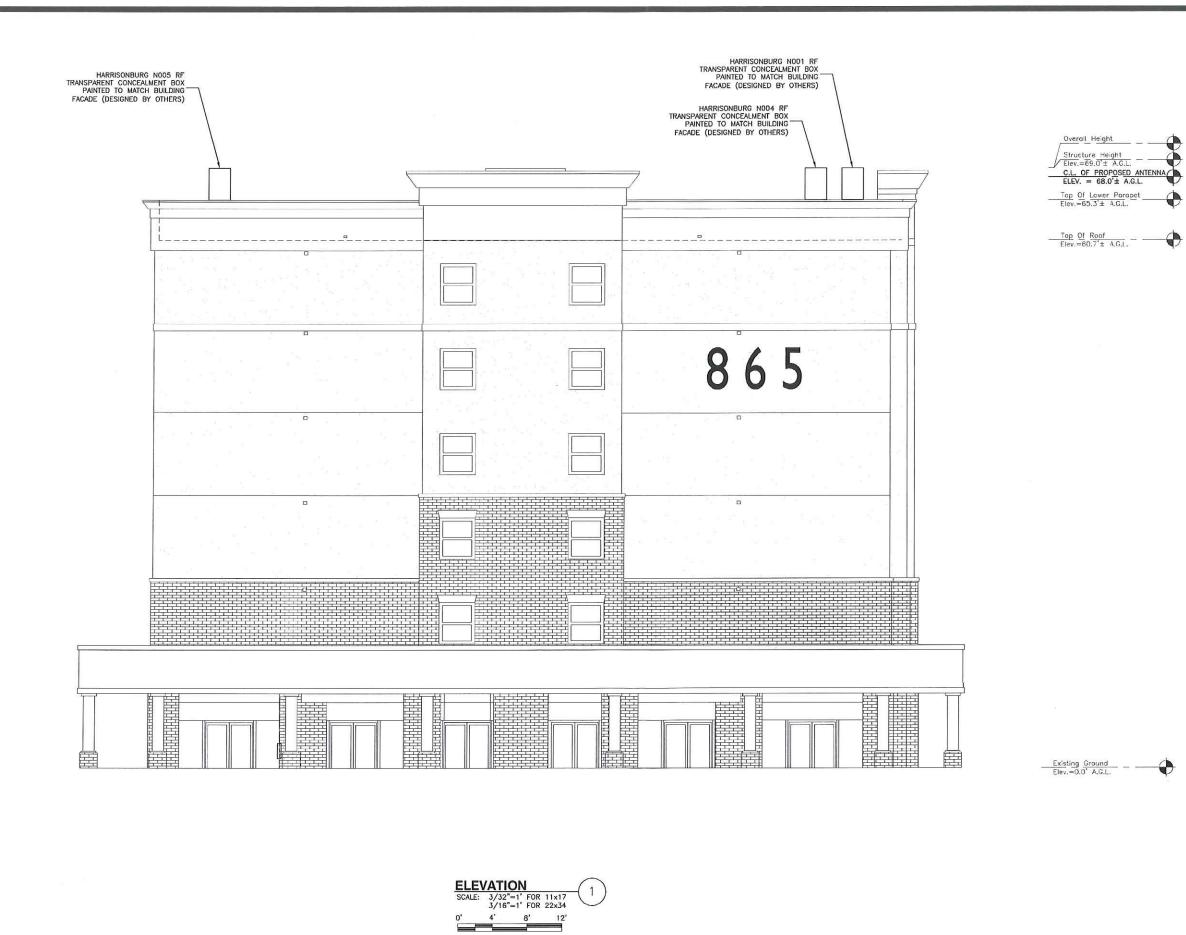
865 PORT REPUBLIC ROAD HARRISONBURG, VA 22801

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INTERIOR PLANS

SHEET NUMBER

C-4



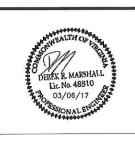

VERIZON WIRELESS 1831 RADY COURT RICHMOND, VA 23222


HARRISONBURG N001, N004, & N005

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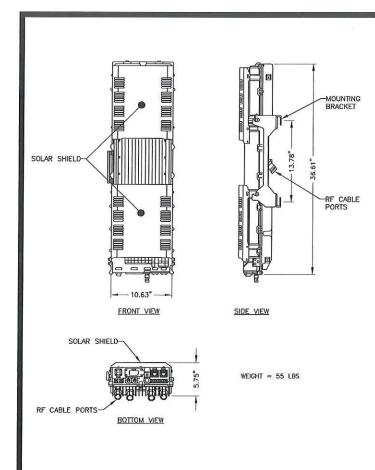
865 PORT REPUBLIC ROAD HARRISONBURG, VA 22801


SHEET TITLE

**ELEVATION** 

SHEET NUMBER

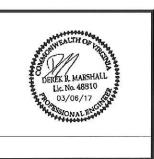C-5



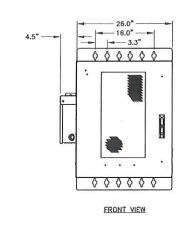


- 24.0"


BOTTOM VIEW

-(4) Ø0.63" HOLES


ø1.75"/ø2.50 KNOCKOUTS

-(2) Ø1.37" KNOCKOUTS

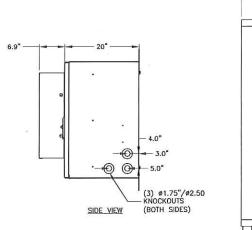


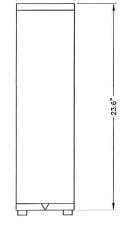


**→** 6.7" — ►

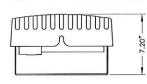

TOP VIEW

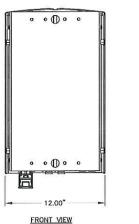

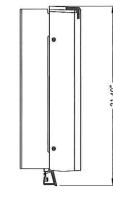


SIDE VIEW

4

PCS RRH4x30-B25 (REMOTE RADIO HEAD)

SCALE: N.T.S.

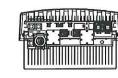

BOTTOM VIEW

DEREK R MARSHALL Lic No. 48810 03/06/17

Dewberry Engineers Inc.

**verizon** wireless

VERIZON WIRELESS 1831 RADY COURT RICHMOND, VA 23222

**HARRISONBURG** N001, N004, & N005

CONSTRUCTION DRAWINGS

0 03/06/17 FOR CONSTRCUTION

Dewberry

DRAWN BY:	N
REVIEWED BY:	DI
CHECKED BY:	DF
PROJECT NUMBER:	500751

SITE ADDRESS:

865 PORT REPUBLIC ROAD HARRISONBURG, VA 22801

SHEET TITLE

CONSTRUCTION DETAILS

SHEET NUMBER









BOTTOM VIEW

FRONT VIEW

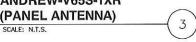

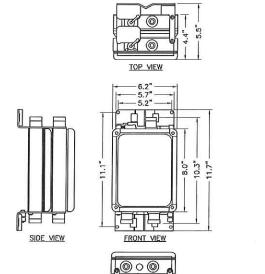

BOTTOM VIEW

5

**DIPLEXER DETAIL** 


			HARRISONE	URG NOO	1 RF SY	STEM SC	CHEDULE	
ANTENNA SECTOR	STATUS	ANTENNA MANUFACTURER	ANTENNA MODEL	RAD CENTER	ANTENNA AZIMUTH	DOWN TILT	RRH QUANTITY & MODEL	CABLE SIZE AND QUANTITY
ALPHA	PROPOSED	ANDREW	V65S-1XR	68'	310*	6*	(1) PCS RRH4x30-B25 (1) AWS RRH2x60	(2) - 1/2"ø


			HARRISONE	URG NOO	4 RF SY	STEM SC	CHEDULE	
ANTENNA SECTOR	STATUS	ANTENNA MANUFACTURER	ANTENNA MODEL	RAD CENTER	ANTENNA AZIMUTH	DOWN TILT	RRH QUANTITY & MODEL	CABLE SIZE AND QUANTITY
ALPHA	PROPOSED		V65S-1XR 68'		451	(1.2)	(1) PCS RRH4x30-B25	(4) 1/2"6
		ANDREW V65S-		68'	45' 0'	(1) AWS RRH2x40	(4) - 1/2"ø	

				RF SYST	EM SCHE	DULE	788	
ANTENNA SECTOR	STATUS	ANTENNA MANUFACTURER	ANTENNA MODEL	RAD CENTER	ANTENNA AZIMUTH	DOWN TILT	RRH QUANTITY & MODEL	CABLE SIZE AND QUANTITY
ALPHA		ANDREW V65S-1XR	V65S-1XR 68'		1051	W-10-1	(1) PCS RRH4x30-B25	(2) 1/2"4
	PROPOSED			125	125' 0'	(1) AWS RRH2×60	(2) - 1/2"ø	

### NOTES:

- CONTRACTOR TO VERIFY ANTENNA INFORMATION WITH CONSTRUCTION MANAGER PRIOR TO CONSTRUCTION.
   CONTRACTOR TO VERIFY PROPOSED ANTENNA INFORMATION IS THE MOST CURRENT DATA AT TIME OF CONSTRUCTION.
   CONTRACTOR TO CONFIRM CABLE LENGTHS PRIOR TO CONSTRUCTION.
   CONTRACTOR IS RESPONSIBLE TO BUILD FROM THE LATEST RF SHEET.

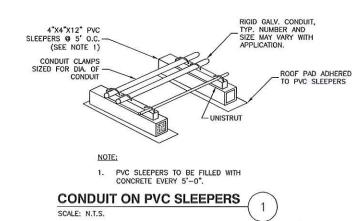


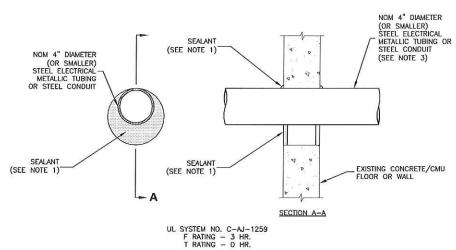

### NOTES:

- FILL, VOID OR CAVITY MATERIAL\* SEALANT MIN. 1/2" THICKNESS OF FILL MATERIAL APPLIED WITHIN THE ANNULUS, FLUSH WITH BOTH SURFACES OF FLOOR OR WALL. AT THE POINT CONTACT LOCATION BETWEEN PENETRATING ITEM AND CONCRETE, A MIN. 1/4" THICK BEAD OF FILL MATERIAL SHALL BE APPLIED AT THE CONCRETE/ PENETRATING ITEM INTERFACE ON BOTH SIDES OF FLOOR OR WALL.
- FORMING MATERIAL (OPTIONAL, NOT SHOWN) MINERAL WOOL BATT PACKING MATERIAL OR POLYURETHANE BACKER ROD FRICTION FITTED INTO OPENING AND RECESSED FROM FLOOR OR WALL SURFACES AS REQUIRED TO ACCOMMODATE THICKNESS OF FILL MATERIAL.
- 3. ONE CONDUIT TO BE INSTALLED EITHER CONCENTRICALLY OR ECCENTRICALLY WITHIN THE FIRESTOP SYSTEM. THE ANNULAR SPACE BETWEEN THE CONDUIT AND THE PERIPHERY OF THE OPENING SHALL BE A MIN. OF O" (POINT OF CONTACT) TO A MAX. OF 3". CONDUIT TO BE RIGIDLY SUPPORTED ON BOTH SIDES OF FLOOR OR WALL ASSEMBLY.
  - \* BEARING THE UL CLASSIFICATION MARK.

CORING DETAIL
SCALE: N.T.S. 3

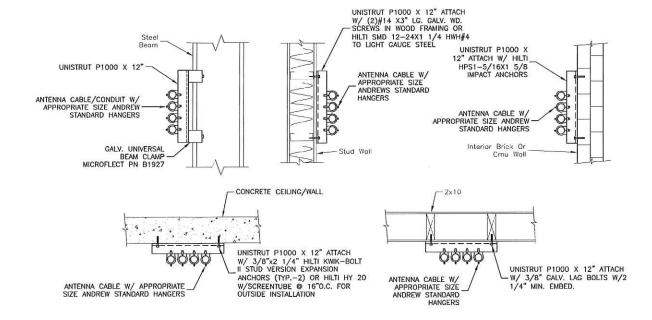

#### NOTES:

- ALL COAX CABLE SUPPORT SPACING: 4'-0" MAX.
- ALL CONDUIT SUPPORT SPACING:
   10' MAX.

CABLE CONDUIT SUPPORT 2



VERIZON WIRELESS 1831 RADY COURT RICHMOND, VA 23222


HARRISONBURG N001, N004, & N005

C	ONSTRUC	TION DRAWINGS
0	03/06/17	FOR CONSTRCUTION



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www.dewbery.com

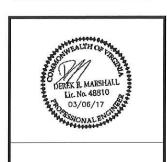

DRAWN BY:	MAF
REVIEWED BY:	DRM
CHECKED BY:	DRM
PROJECT NUMBER:	50075169

1			_	
	SITE	ADDRESS:		


865 PORT REPUBLIC ROAD HARRISONBURG, VA 22801

SHEET TITLE

CONSTRUCTION DETAILS


SHEET NUMBER

C-7

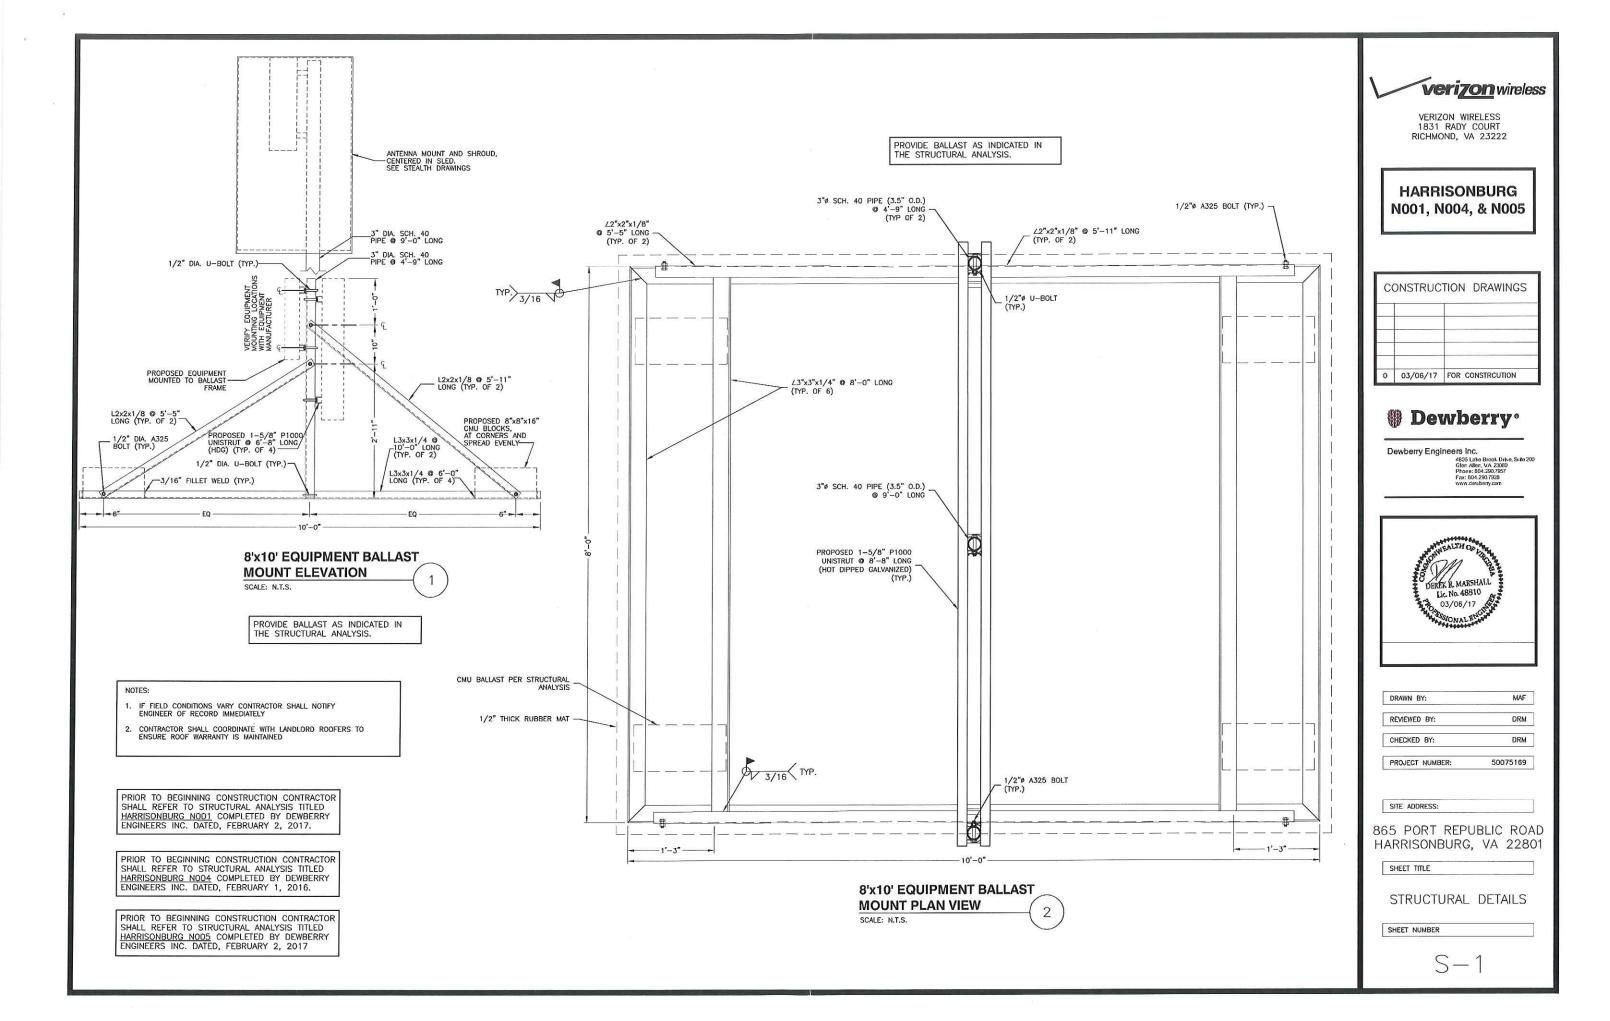



- IF FIELD CONDITIONS VARY CONTRACTOR SHALL NOTIFY ENGINEER OF RECORD IMMEDIATELY
- CONTRACTOR SHALL COORDINATE WITH LANDLORD ROOFERS TO ENSURE ROOF WARRANTY IS MAINTAINED

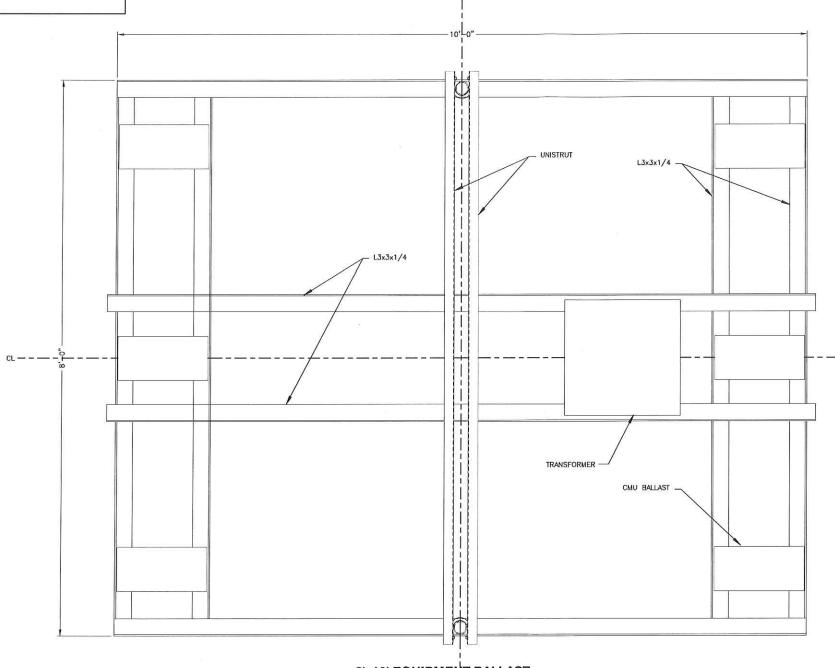

CL

PRIOR TO BEGINNING CONSTRUCTION CONTRACTOR SHALL REFER TO STRUCTURAL ANALYSIS TITLED HARRISONBURG NOO1 COMPLETED BY DEWBERRY ENGINEERS INC. DATED, FEBRUARY 2, 2017.

PRIOR TO BEGINNING CONSTRUCTION CONTRACTOR SHALL REFER TO STRUCTURAL ANALYSIS TITLED HARRISONBURG NO04 COMPLETED BY DEWBERRY ENGINEERS INC. DATED, FEBRUARY 1, 2016.

PRIOR TO BEGINNING CONSTRUCTION CONTRACTOR SHALL REFER TO STRUCTURAL ANALYSIS TITLED HARRISONBURG NOO5 COMPLETED BY DEWBERRY ENGINEERS INC. DATED, FEBRUARY 2, 2017

8'x10' EQUIPMENT BALLAST MOUNT PLAN VIEW

SCALE: N.T.S.

PROVIDE BALLAST AS INDICATED IN THE STRUCTURAL ANALYSIS.



VERIZON WIRELESS 1831 RADY COURT RICHMOND, VA 23222


HARRISONBURG N001, N004, & N005

C	ONSTRUC	TION DRAWINGS
0	03/06/17	FOR CONSTRCUTION



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DRAWN BY:	MAF
REVIEWED BY:	DRM
CHECKED BY:	DRM
PROJECT NUMBER:	50075169

SITE	ADDRESS:	

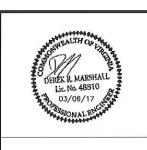865 PORT REPUBLIC ROAD HARRISONBURG, VA 22801

SHEET TITLE

STRUCTURAL DETAILS

SHEET NUMBER

S-2