

Date Application Received: 05-06-16 *updated May 4, 2018*

Application for Special Use Permit City of Harrisonburg, Virginia

Fee: \$375.00 plus \$30.00 per acre

Total Paid: \$ 405.⁰⁰ AP
+ \$202.50 7#D 6/13/18

Property Owner's Name: H2 Investments, LLC

Street Address: 1500 Pleasants Drive Email: _____

City: Harrisonburg State: VA Zip: 22801

Telephone: Work 540-564-1986 Fax _____ Mobile _____

Owner's Representative: William S. Moore, PE - Balzer and Associates, Inc.

Street Address: 128 West Market St, Suite 103 Email: wmoore@balzer.cc

City: Harrisonburg State: VA Zip: 22801

Telephone: Work 540-433-1908 Fax _____ Mobile _____

Description of Property and Request

Location (Street Address): 753 Foley Road

Tax Map Number Sheet: 84 Block: A Lot: 9 Lot Area: 0.536 Acre

Existing Zoning Classification: R-3 Medium Density Residential

Special Use being requested: Multi-Family Dwellings up to 12 units per building

Please provide a detailed description of the proposed (use additional pages may be attached): _____

Multi-Family Dwellings with up to 12 units per building and associated parking.

Names and Addresses of Adjacent Property Owners (Use separate sheet for additional names)

North: Kathy Lynn Hite, P.O. Box 1552, Gloucester, VA 23061

South: N/A (Foley Rd)

East: Forrest Rucker, Jr. & Mary Ann Rucker, 708 Stuart St, Harrisonburg VA 22802

West: J&K Enterprises, LLC, 71 East Market Street, Harrisonburg, VA 22801

Certification: *I certify that the information contained herein is true and accurate.*

Signature: *[Handwritten Signature]*
Property Owner

ITEMS REQUIRED FOR SUBMISSION

- Completed Application
- Site Plan
- Description of Proposed Use
- Adjacent Property Owners

- Fees Paid
- Property Located on Tax Map
- _____
- _____



May 4, 2018

City of Harrisonburg
Department of Planning & Community Development
Attn: Alison Banks
409 South Main Street
Harrisonburg, Virginia 22801
540-432-7700
alisonb@ci.harrisonburg.va.us


Re: Special Use Permit Request
753 Foley Road
Balzer Project # 44160004

Ms. Banks,

On behalf of the property owner, Balzer and Associates, Inc. is providing this summary letter to address the required conditions outlined in City Ordinance Article J.2, Section 10-3-48.6, Paragraph (e):

1. Existing multiple-family development is located immediately adjacent to the subject parcel to the west and across the street to the south. Other similar developments exist to the east within 220-ft of the subject parcel.
2. Adequate vehicular, transit, and bicycle facilities serve the site. A new sidewalk is proposed along the property frontage which will connect to an interior sidewalk and bike rack (see Concept Site Plan prepared by Balzer & Associates, dated 05-04-2018).
3. The proposed building design will be 3-story structures with residential style exterior finishes and possible garage spaces. Landscaping will be provided in accordance with the City Ordinance. Mechanical equipment will be placed to the rear of the buildings, which will be screened. Parking spaces will also be screened from adjoining properties.
4. The Concept Site Plan illustrates how the site is generally suitable for the proposed development. With the proposed layout of the parking and building, area for open space can be created as an amenity for the residents. An approved site plan will be obtained for final site development to address specific building locations, parking areas, and site grading.

BALZER AND ASSOCIATES, INC.

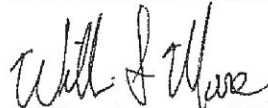
William S. Moore, PE
Associate

Planners • Architects • Engineers • Surveyors

Roanoke • Richmond • New River Valley • Staunton • Harrisonburg

128 West Market Street, Suite 103 • Harrisonburg, Virginia 22801 • (540) 433-1908 • www.balzer.cc



City of Harrisonburg, VA
 Department of Public Works

Determination of Need for a
 Traffic Impact Analysis (TIA)

www.harrisonburgva.gov/traffic-impact-analysis

Contact Information	
Consultant Name:	William S. Moore, Balzer & Associates
Telephone:	540-433-1908
E-mail:	wmoore@balzer.cc
Owner Name:	Hans Harman, H2 Investments, LLC
Telephone:	540-746-8826
E-mail:	hans@momentumearthworks.com
Project Information	
Project Name:	753 Foley Road
Project Address: TM #:	753 Foley Road, 84-A-9
Existing Land Use(s):	Residential, Vacant
Proposed Land Use(s): (if applicable)	Residential (Apartments)
Submission Type:	Comprehensive Site Plan <input type="radio"/> Special Use Permit <input checked="" type="radio"/> Rezoning <input type="radio"/> Preliminary Plat <input type="radio"/>
Project Description: (Include site plan or preliminary sketch and additional details on land use, acreage, access to site, etc)	7 Apartment Units Refer to Concept Site Plan prepared by Balzer & Associates, dated 05-04-2018
Peak Hour Trip Generation (from row 15 on the second page)	
AM Peak Hour Trips:	7
PM Peak Hour Trips:	7

(reserved for City staff)

TIA required? Yes _____ No X

Comments:

Accepted by: [Signature]

Date: 7/5/18

Peak Hour Trip Generation by Land Use


Row	Land Use	ITE Land Use Code	Unit	Quantity	AM Peak Hour of Adjacent Street Traffic	PM Peak Hour of Adjacent Street Traffic
1	Proposed #1	221	DU	7	7	7
2	Proposed #2					
3	Proposed #3					
4	Proposed #4					
5	Proposed #5					
6	Proposed #6					
7	Total New Trips					
8	Existing #1					
9	Existing #2					
10	Existing #3					
11	Existing #4					
12	Existing #5					
13	Existing #6					
14	Total Existing Trips					
15	Final Total (Total New – Total Existing)				7	7

Instructions

Determination of trip generation rates shall be in conformance with ITE guidelines.

1. Based on the intended use(s), calculate the AM Peak and PM Peak trip generation using the AM and PM Peak Hour of Adjacent Street Traffic rates from the most current version of the ITE Trip Generation Manual (rows 1-6). Attach additional sheets as necessary for more uses.
2. Sum up all of the trips generated for the new uses in the Total New Trips row (row 7).
3. If the development has any existing uses, calculate the AM Peak and PM Peak trip generations using the AM and PM Peak Hour of Adjacent Street Traffic rates from the most current version of the ITE Trip Generation Manual (rows 8-13). Attach additional sheets as necessary for more uses.
4. Sum up all of the trips generated for the existing uses in the Total Existing Trips row (row 14).
5. Subtract the total existing trips from the total new trips to get the final total number of trips generated by the development (row 15). Enter these numbers on the first page.

- NOTES:
- 0.526 ACRES
 - 7 APARTMENT UNITS (2 OR 3 BEDROOM), 3 STORIES.
 - DENSITY = 13.3 UNITS PER ACRE
 - 18 PARKING SPACES REQUIRED.
 - POSSIBLE GARAGE SPACES.
 - OPEN SPACE FOR BENCH, TABLE, TOT LOT, ETC.
 - ALL HVAC UNITS SHALL BE SCREENED.

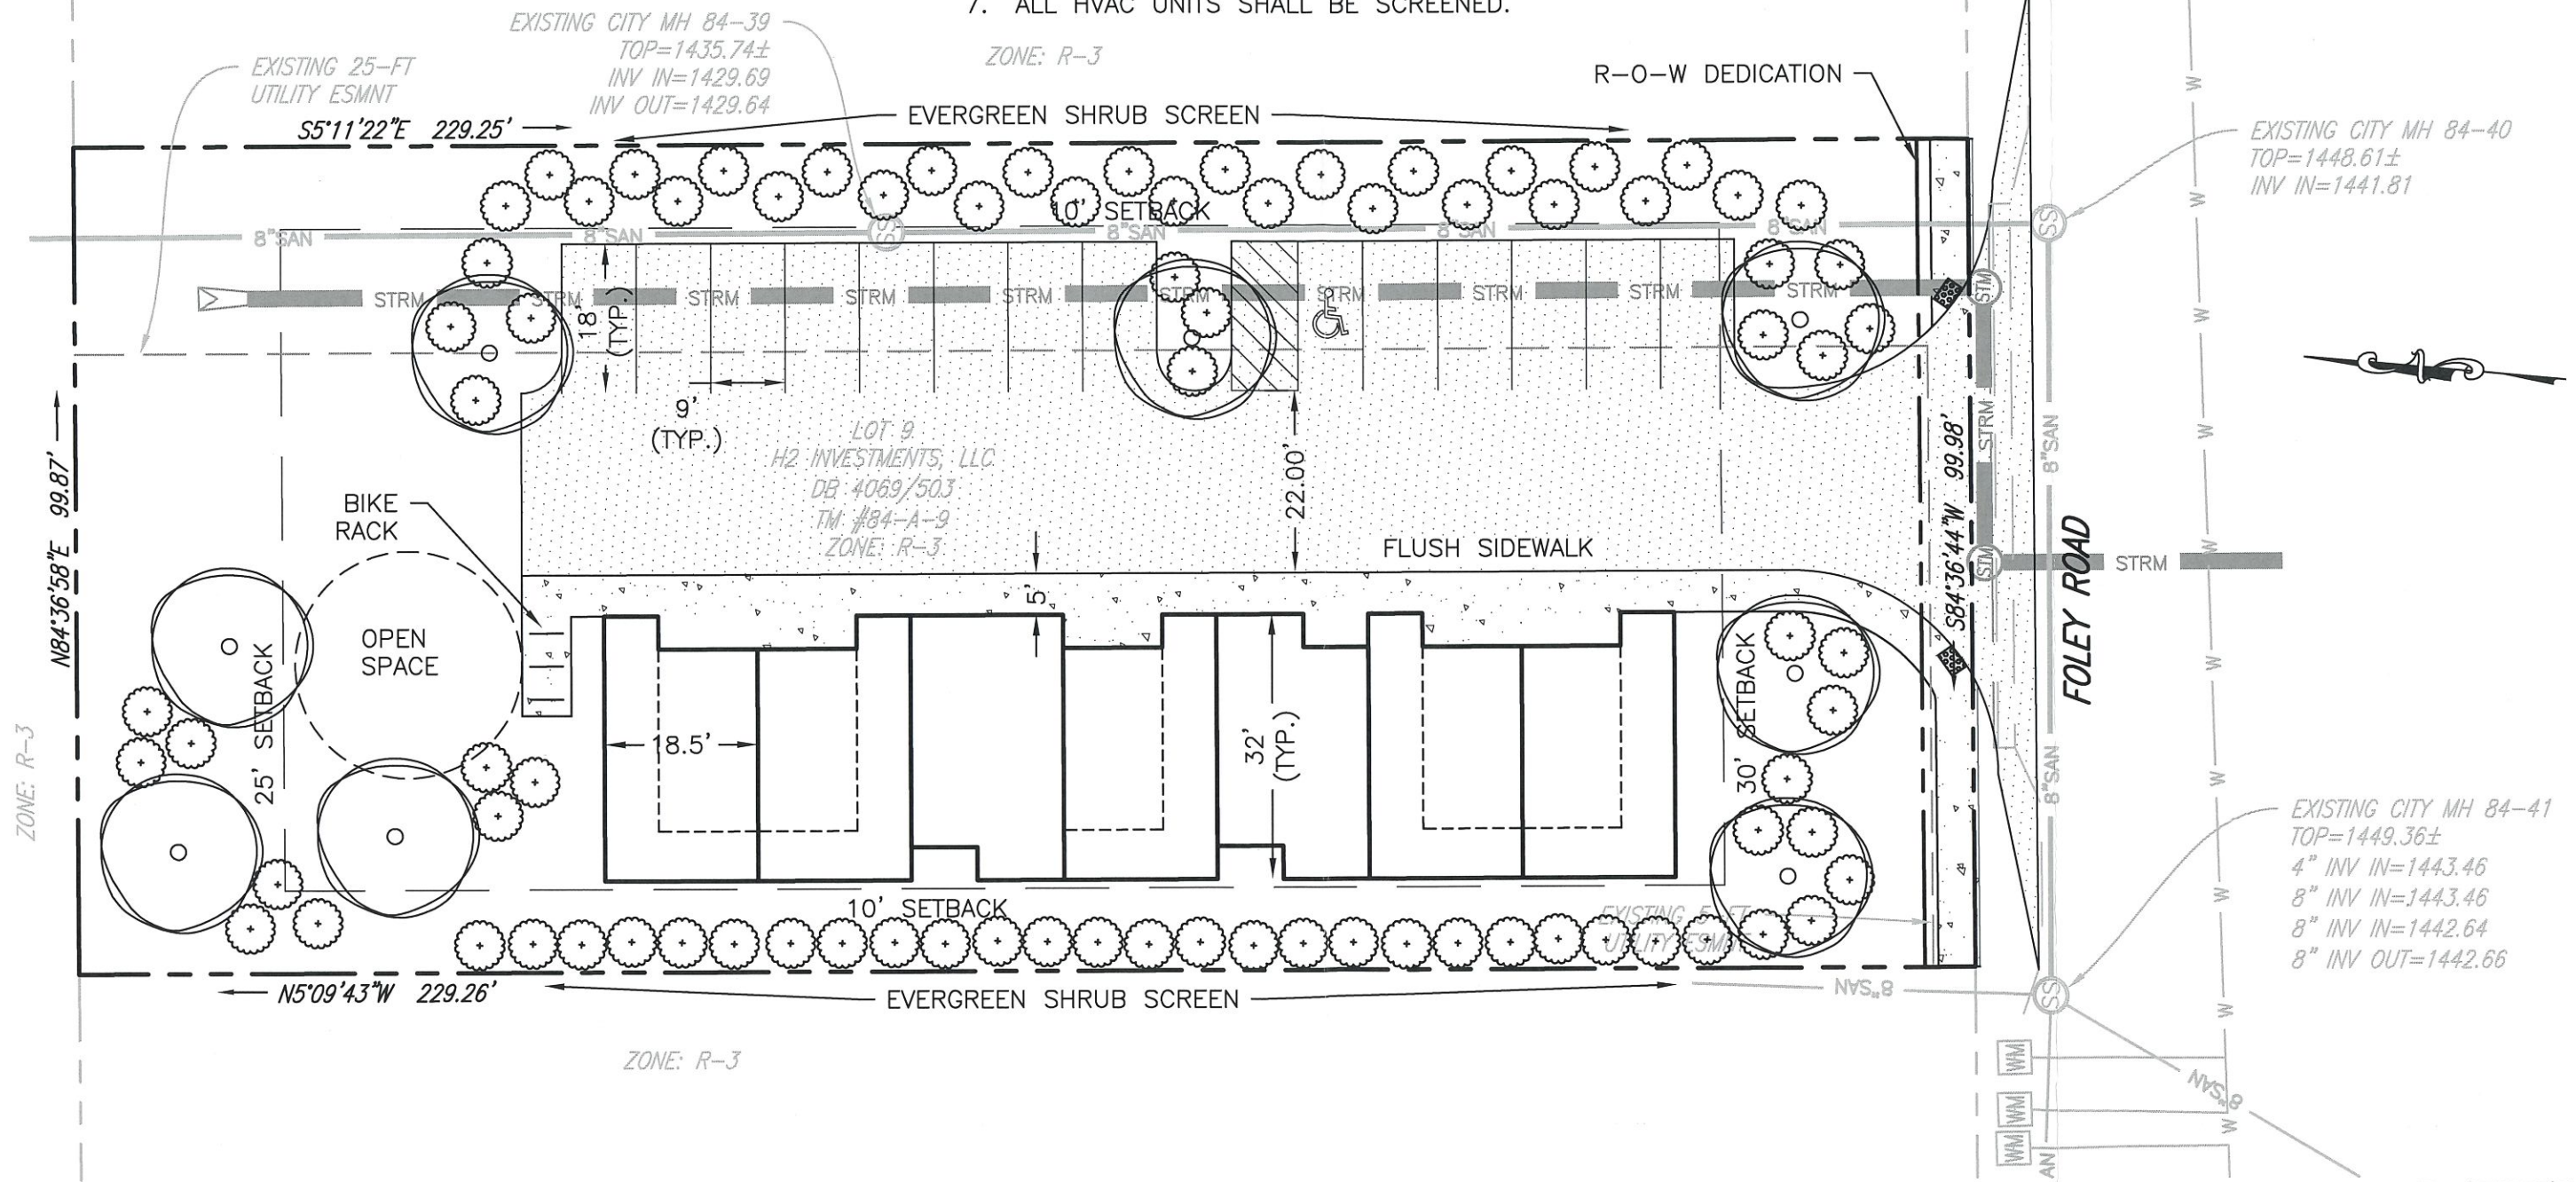

DATE: 05-04-2018
 SCALE: 1" = 20'
 JOB NO: 44160004
 DRAWN BY: TKP
 SHEET 1 OF 1

753 FOLEY ROAD CONCEPT SITE PLAN

CITY OF HARRISONBURG, VIRGINIA

PLANNERS • ARCHITECTS • ENGINEERS • SURVEYORS
 ROANOKE • RICHMOND • STAUNTON • HARRISONBURG • CHRISTIANSBURG
 128 West Market Street Suite 103 Harrisonburg, VA 22801 (540)433-1908

